

**CITY OF HOLLYWOOD, FLORIDA
INTER-OFFICE MEMORANDUM
OFFICE OF PLANNING**

DATE: November 18, 2010 **FILE:** 10-DPV-59

TO: Development Review Board

VIA: Andria Wingett, Planning Manager *AW*

FROM: Leander Hamilton, Planning Administrator *LH*

SUBJECT: Margaritaville Hollywood Beach Resort, LLC requests a Variance, Design approval and a recommendation to the City Commission for Site Plan approval for a 349 room hotel including restaurant, retail, banquet hall, swimming pools, and associated public/private parking garage generally located at 300 Johnson Street/1112 N. Ocean Drive (Generally located north of Michigan Street, south of Johnson Street, east of the Intracoastal Waterway and west of the Atlantic Ocean)

APPLICANT'S REQUEST:

Design approval and a recommendation to City Commission for Site Plan approval for a 349 room hotel, public/private parking garage and other amenities.

Also included is a Variance request to waive the requirements of Article 8 of the City of Hollywood's Zoning and Land Development Regulations to approve signage for Margaritaville Hollywood Beach Resort.

STAFF'S RECOMMENDATION:

Variance: Approval, subject to any changes the City Commission may deem necessary while considering the Site Plan.

Design: Approval, subject to any changes the City Commission may deem necessary while considering the Site Plan.

Site Plan Recommendation: Approval, if Design is granted.

HISTORY

The City-Wide Master Plan describes this property as *providing potential for an anchor for Central Beach and recommending to remove free standing parking structures such as the one at Johnson Street that can be integrated into the Johnson Street Parcel to create replacement parking and a more attractive urban environment.* As seen later in the report, this development has been designed in a manner which embodies the recommendations within this document to

provide an attractive building with a layout that engages the public and enhances the beach. In 2009 the City Commission requested a Request For Proposals (RFP). This proposal was for a public private partnership to build a signature hotel including a public parking garage, ballroom, retail and restaurant space at property formally known as the "Casino Property". This development would be slated to replace the 592 space Maurice H. Connell parking garage, 208 surface parking spaces (includes on street), and a portion of the Public Works Beach Maintenance area.

As a result, on April 7, 2010 the City Commission received presentations by two bidders for redevelopment of City owned property generally located at Johnson Street and A1A. Thus, Margaritaville Hollywood Beach Resort was selected to partner with the City.

In 2005, the Comprehensive Plan was updated to include Evaluation and Appraisal Report (EAR) based amendments. Policy 7.39 references *giving priority for using shoreline properties for land uses that are water dependent, public in nature and promote tourism*. Furthermore, Policy 10.1.b. describes development of land in the context of a public/private partnership. Some goals and objectives identified specifically for the Beach Community Redevelopment Agency (BCRA) include:

- ❖ Develop the Johnson Street beach property as the village center of Hollywood Beach.
- ❖ Re-establish tourism as a vital industry.
- ❖ Enhance Hollywood Beach as a tropical destination.
- ❖ Promote redevelopment and eliminate the causes of physical and economic blight.
- ❖ Create opportunities and incentives that facilitate redevelopment of private properties.

REQUEST

The request before the Development Review Board is for Design approval and a recommendation to the City Commission for Site Plan approval for a hotel, public/private parking garage, retail, and restaurant space. Located on two plots totaling just over five acres, this project is on City owned property within the BCRA. The property spans from the Intracoastal Waterway to the Boardwalk between Johnson and Michigan Streets.

There are two plots associated with this request; east parcel (along the Intracoastal Waterway) and west parcel (ocean side). Included in the scope of work are the following:

East Parcel

- Up to 456 garage hotel parking spaces
- Up to 600 garage public parking spaces
- 349 hotel rooms
- 25,500 sq ft restaurant and retail space
- 22,604 sq ft ballroom
- 15,500 full-service spa and fitness area
- Pool deck
 - Lagoon pool and Volcano Water Slide pool
 - Ridin' In Style wave simulation pool
 - Lone Palm Bar
 - Air Stream Bar
 - Captain Tony's Pizza Shack/Tiki Treats snack bar.

- Two outdoor event lawns

West Parcel

- Dock with pavilion and public restrooms

This east parcel is lined with several hotel restaurants along A1A, Johnson Street and the Broadwalk. Results from the Florida Building Commission Meeting allow for retail, restaurant and a swimming pool to span the length of the Broadwalk at approximately the same elevation. The main entrance (including valet) to the hotel is along A1A with back-of-house operations along Michigan Street. The hotel layout includes upscale dining and a Margaritaville Restaurant on the first floor; a spa and fitness area on the second floor; a grand ballroom at the ninth level; and an outdoor event lawn overlooking the beach at the eleventh level. Guest rooms begin at the ninth level and continue to the eighteenth floor. A mix of rooms is provided and range from 428 sq ft to 3,178 sq ft in the Presidential Suite. The Planning and Zoning Board will consider allocation of 39 rooms from the Hollywood Beach Hotel Room Pool (the total number of rooms remains 349).

The garage is designed with the main entrance on Johnson Street while visitors leaving will exit directly onto Michigan Street. The applicant has worked with the Florida Department of Transportation to receive approval for a new signal in this area to help manage traffic flow. Mechanical lifts will help accommodate valet parking on the third and eighth floors with public and hotel (self) parking on levels five through seven.

A variety of setbacks have been provided at different levels of the building. For example, along A1A the building pedestal provides a setback ranging from 29' at the northwest corner to 98' at the southwest corner. Setbacks along the side streets are 20' and 27' at the closest points. As a result of integrating the beachfront atmosphere into the design, much of the building mass is contained on the western portion of the property. As such, the east setback ranges from 123'-240' on the first level. As the building gets taller, setbacks increase. For example, at the eleventh level (114') building setbacks increase to 362' on the east side. These variations continue upward creating a horseshoe shape. At the tallest point the building is 208' (17 stories). The west parcel (pavilion and public restrooms) has setbacks ranging from 10'-140' (15' north, 140' south, 10' east, 17' west) and has 5 employee parking spaces.

The Variance request is to waive the requirements of Article 8 (Signs) of the Zoning and Land Development Regulations. The Purpose of the City's Sign Regulations is to permit signs that will: 1) Not by their size, location, construction or manner of display, endanger the health, safety and general welfare of the public; 2) Be architecturally and aesthetically compatible with the buildings they are placed on and; 3) Be efficient in the transfer of information. Due to the scale and nature of this development larger signage is needed than what is typically seen. Additionally, sign regulations for the Government Use (GU) designation do not take into account the variety of uses which may be used under this category. As such, they mostly account for smaller scale development and are restrictive in nature. Additionally, this establishment has been designed to be a landmark for locals and visitors from all parts of the nation. It offers a number of private and public amenities and its success will help fuel the economic engine on the beach. As such, it is crucial proper signage is provided for identification and to welcome all patrons. It is under these special conditions, this request is made. The applicant has provided a detailed legend indicating the location, size, and design of all signs proposed for this

development (See Attachment B). These signs meet the intent of the code, are complimentary to the development, provided needed visibility of this notable establishment.

Due to the GU zoning designation, the Development Review Board will make a final decision on the Variance and Design and forward a recommendation for Site Plan approval to the City Commission. As such, staff recommends Variance and Design be approved; however, it is still subject to any changes the City Commission may deem necessary while considering the Site Plan.

SITE INFORMATION:

Owner/Applicant:	City of Hollywood/Margaritaville Hollywood Beach Resort, LLC.
Address/Location:	300 Johnson Street/1112 N. Ocean Drive
Gross Size of Property:	6.2 acres (east)/ 0.47 acres (west)
Future Land Use:	General Business
Zoning:	Government Use (GU)
Existing Use of Land:	Maurice H. Connell Parking Garage, surface parking, maintenance building and beach exercise area

ADJACENT FUTURE LAND USE

North: General Business
South: General Business
East: Open Space and Recreation
West: General Business & Intracoastal Waterway

ADJACENT ZONING

North: Beach Resort Commercial District, Broadwalk Historic District Commercial & Beach Resort A1A Commercial District (BRT-25-C, BWK-25-HD-C & BRT-25-A1A-C)
South: Beach Resort Commercial District, Broadwalk Historic District Commercial & Beach Resort A1A Commercial District (BRT-25-C, BWK-25-HD-C & BRT-25-A1A-C)
East: Broadwalk & Atlantic Ocean
West: Beach Resort A1A Commercial District (BRT-25-A1A-C & Intracoastal Waterway)

CONSISTENCY WITH THE COMPREHENSIVE PLAN

The proposed project is located in the General Business Land Use area. The overriding goal of the Land Use Element is to *provide a framework for rational decision-making regarding the uses and re-use of land in a mature community characterized by infill on previously passed over parcels and by intensification of use of land through redevelopment and rehabilitation.* Incorporated into the Comprehensive Plan in 2004 some general principles and Guiding Principles utilized to create the City-Wide Master Plan include:

- ❖ *Emphasizing the qualities of the City of Hollywood's historic urban plan and built environment.*
- ❖ *Preserve and emphasize historic resources and Joseph Young's original vision for the City of Hollywood.*

- ❖ *Identifying areas to channel public investments and actions to accomplish the City's sustainability and development goals.*
- ❖ *Promote the highest and best use of land in each sector of the City without compromising goals of the surrounding community.*

Land Use Element

Objective 3: Prohibit any increase in the number of permanent residential dwelling units on the Coastal High Hazard Area above that permitted by the adopted Comprehensive Plan.

Policy 3.1: Continue to encourage commercial and seasonal uses along Central Beach and prohibit an increase in the number of permanent residential dwelling units above the permitted by the adopted Comprehensive Plan...

Policy 5.4: Continue redevelopment of Central Beach.

Policy 7.38: Prioritize shoreline land uses based on water use and tourism.

Policy 7.39: Review and amend the Zoning and Development Regulations and the Zoning Map as needed to give priority for using shoreline properties for land uses that are water dependent, public in nature and promote tourism.

Policy 8.3: Maintain the Zoning and Development Regulations that ensure the adequate provision of public services and facilities for tourist and seasonal populations.



Policy 10.1b: Investigate and consider the acquisition and development potential of CRA-owned land in the context of private development or a public/private partnership.

Policy 10.10: Require mixed-uses on the perimeter of new parking structures with pedestrian orientation and architectural features, where appropriate. (CWMP Policy 4.6)

General Business areas are designed to facilitate commercial uses including shopping centers, offices, hotels, motels and other tourist accommodations. Central Beach has the largest distribution of this land use on the barrier island. As such, hotels are consistent with this land use. An assortment of amenities will provide additional uses such as restaurant and a wave simulation pool, thereby encouraging tourists to remain on Hollywood's Beach. Although not being considered by this Board, the allocation of additional rooms from the "Hollywood Beach Hotel Room Pool" is consistent with a General Business land use.

CONSISTENCY WITH THE CITY-WIDE MASTER PLAN (CWMP)

Located within Sub-area 4, Central Beach is bounded by Harrison Street to the south and Sherman Street to the north on the barrier island. Central Beach has a mix of uses, such as residential, commercial, hotels and motels. The subject property's existing conditions are described as *providing potential for an anchor for Central Beach...* Specific recommendations for this property are identified in two options, both of which include a hotel, parking garage, retail, and plaza/activity space:

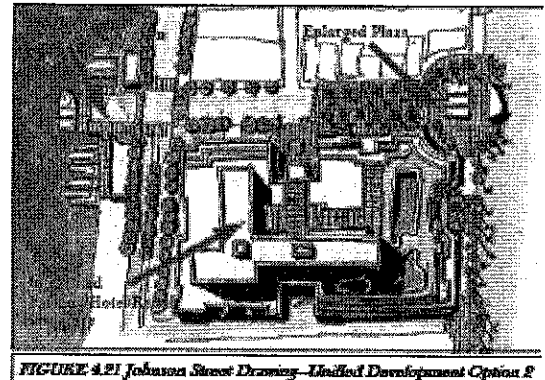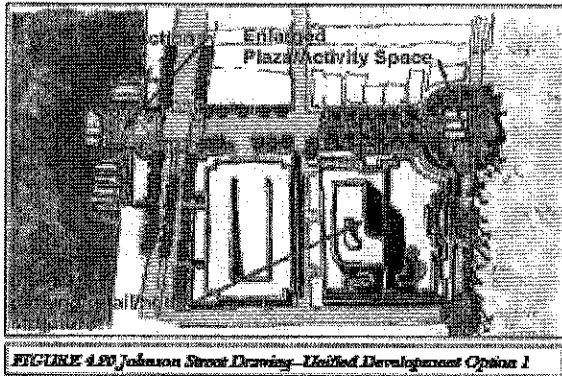

Current issues identified include ensuring future development patterns of Central Beach are consistent with the character of neighborhoods, economic revitalization, public access and open space along the Intracoastal and parking for residents and visitors. Recommendations include:

- ❖ *Johnson Street Development Node should be developed as an important development node.*
- ❖ *Develop the Johnson Street/Casino Property to include within the development parcel the existing parking structure facing A1A. Require replacement of public parking for the spaces included in the present parking structure, allow the use of air rights of the existing parking deck, require people friendly uses (retail, residential, hotel) to wrap around the parking so as not to make it visible from the street and soften its appearance. This property may include residential, hotel use, ground floor tourist-oriented retail activities, office space, community or public use and general parking.*
- ❖ *Prohibit and work to remove free standing parking structures such as the one at Johnson Street that can be integrated into the Johnson Street Parcel to create replacement parking and a more attractive urban environment. To accomplish this, line parking structure with people friendly uses at ground level such as retail stores or offices, residential and or hotel uses.*
- ❖ *Designation of specific commercial and development nodes...*

Policy 4.2: Concentrate retail commercial activities in defined development centers to build critical commercial mass at appropriate locations that are compatible with neighborhoods and with beach redevelopment objectives.

Policy 4.5: Promote the development of desired commercial uses in defined sector and pockets along the Broadwalk and Ocean Drive.

Policy 4.6: Require mixed-uses on the perimeter of new parking structures with pedestrian orientation and architectural features, where appropriate.

Policy 4.7: Require the construction of replacement parking spaces in cases where existing parking structures are included as a part of an incentive.

Policy 4.16: Recognize Central Beach as a prime focus of tourist activities.

Policy 4.32: Upgrade the quality of seasonal accommodations and commercial activities by promoting the renovation and construction of higher quality lodging.

Policy 4.33: Create public spaces and development nuclei that will become areas of community focus, highlighting the uniqueness of each area of Hollywood Beach, to create a sense of place and anchors of activity, which will create opportunities and incentives for development.

Policy 4.34: Work within the framework of the Beach CRA to implement the Master Plan vision for Hollywood Beach within the CRA boundaries.

Policy 4.37: Encourage development and redevelopment of hotel and motels in an effort to increase tourism.

Policy 4.59: Create a public plaza on Johnson Street, utilizing the band shell/amphitheater as the focal point.

Policy CW.47: Focus beach redevelopment efforts to capitalize on tourist economy.

Created by the residents, the CWMP has envisioned redevelopment of this site to include a hotel, parking garage, and retail space. The City and developer both recognize the importance of creating a signature project to attract tourists. As described in this report the proposed project achieves the goals outlined in the CWMP.

VARIANCE

Waive the requirements of Article 8 of the Zoning and Land Development Regulations to approve for Margaritaville Hollywood Beach Resort.

Analysis of Criteria and Findings for Variance as stated in the City of Hollywood Zoning and Land Development Regulations Section 5.3 F (2). Approval, Approval with Conditions, or Denial will be based on the following criteria:

CRITERION 1: The Variance is not contrary to the public interest.

ANALYSIS: The proposed signage for Margaritaville will still maintain the Code's intent while adhering to a design specifically for this development. The sign legend provided in Attachment B details the location, size and style of each sign. This establishment has been designed to be a landmark for locals and visitors from all parts of the nation. It offers a number of private and public amenities and its success will act as a catalyst for future redevelopment on the beach. As such, it is crucial proper signage is provided for identification and to welcome all patrons. The overall design is compatible with the associated structures aesthetically and in scale and provides the visibility needed for this notable development.

As confirmed by the applicant, "A cohesive and comprehensive signage program will work to strengthen the design and overall public image that Margaritaville conveys to prospective guests and the public. As a key component of the development's signature design and architectural

elements, the signage program also serves to efficiently convey appropriate information about each aspect of the resort, spa and entertainment complex, and in no way serves to act in contrast to public interest."

FINDING: Consistent

CRITERION 2: The variance is required due to special conditions.

ANALYSIS: Due to the scale and nature of this development larger signage is needed than what is typically seen. Additionally, sign regulations for the Government Use (GU) designation do not take into account the unlimited assortment of uses which may be used under this category. As such, they mostly account for smaller scale development and are restrictive in nature. In this instance, more square footage is necessary to ensure proper visibility and recognition of this important development and to provide signs which are compatible with the scale of the buildings.

The applicant stated, "Given the size, importance and purpose of the project, the Applicant is seeking this variance as part of an overall plan to create a world-renowned destination resort to draw both city residents and guests alike to visit and enjoy Hollywood Beach. The resort serves to not only drive the economic engine necessary to revitalize Hollywood Beach, but also to provide an entertainment facility open for the public to use and enjoy. It is based upon these special conditions that the Applicant is requesting this variance, as it is critical that the development create presence and an identity through the use of easily recognizable signage consistent with the architectural and design elements of the resort."

FINDING: Consistent

CRITERION 3: A literal enforcement of the provisions of Article 8 may result in unnecessary hardship.

ANALYSIS: "From a branding and promotional standpoint, it is crucial that Margaritaville's proposed signage creates an easily recognizable image and identity tied into the "Margaritaville" lifestyle which encourages the public to experience the resort, spa and entertainment complex...As such, if the existing signage regulations were literally enforced, Margaritaville's design cohesiveness, image, and most importantly, presence on Hollywood Beach would be diminished (particularly when compared with other resorts of similar scope and importance) thereby creating an economic hardship," expresses the applicant.

The City of Hollywood/BCRA has worked closely with the applicant for the past six months to design a world-class establishment which will attract visitors from all parts of the nation and act as a catalyst for further redevelopment on the beach. Although this development will be well-known to locals, it is essential anyone who passes is able to easily identify

Margaritaville Hollywood Beach Resort. Limitations on the size of the signage cause unnecessary hardships and reduce the ease of identification the message the development is designed to send.

FINDING: Consistent

DESIGN REVIEW

Analysis of Criteria and Findings for Design Review as stated in the City of Hollywood Zoning and Land Development Regulations, Article 5.3(1)(6). Approval with Conditions or Denial will be based on the following criteria:

CRITERION 1: Architectural and Design Components. Architecture refers to the architectural elements of exterior building surfaces. Architectural details should be commensurate with the building mass. The use of traditional materials for new architectural details is recommended. Design of the building(s) shall consider aesthetics and functionality, including the relationship of the pedestrian with the built environment.

ANALYSIS: Well known for its festive, relaxed and inviting atmosphere, the proposed Margaritaville Hollywood Beach Resort is designed to incorporate all of these concepts. Most will recognize the exterior as having a "Key West" appearance with pastel colors and bahama shutters. The applicant describes the architectural style as "a contemporary adaptation of the Caribbean/West Indies Style which uses architectural elements to accentuate the building's elevations and planes with a complementary palate of soft colors and textures." The pavilion and public restrooms on the western parcel are consistent with this design.

An array of materials and features are used to bring forth the intent of the design and tie into the beachfront environment. These include smooth stucco lap siding, crushed shell stucco, pastel colors, decorative railings, a standing seam metal roof, and the use of vines on the east and west elevations.

The front of the hotel is emphasized with a contrasting slate blue roof color on the porte-cochere. This pulls the eye to the center of building where traditional Margaritaville colors climb toward the upper levels and also helps orient pedestrians toward the entrance. Again, the restaurant is highlighted with the blue roof emphasizing the difference in use and creating a break in the building mass. A featured lighthouse which leads to the upper restaurant level is accentuated with a coral rock finish further integrating the development with its surroundings. A series of three smaller outdoor bars/restaurants are all designed to emphasize the festive waterfront theme.

The City's Design Review Manual encourages designs which *take into account pedestrian and vehicular circulation*. As expressed by the applicant, "The design of the building allows for unencumbered

pedestrian access for all public spaces...For example, the plan provides for a seamless transition for pedestrians approaching the building from the Boardwalk, with soft fences and free-form planters running along the perimeter." The front entrance from A1A follows directly through the lobby to the rear of the building where hotel guests can access the Margaritaville restaurant and hotel amenities. Alternatively, a paved walkway wraps around the north side of the building along Johnson Street taking beachgoers to the event lawn and Boardwalk. Johnson Street also accommodates a trolley pick-up/drop-off area, public restrooms and the Great Lawn where everyone can enjoy outdoor entertainment taking place at the Beach Amphitheater. Access to the Ridin' In Style wave simulation pool can be found along the Boardwalk while a restaurant entrance is located on Michigan Street. Lush landscaping is used throughout the site to soften and compliment the architecture. The mix of colorful, native and exotic species works with the architecture to encourage pedestrian activity.

Access to the garage (1056 spaces) is from Johnson Street with exiting traffic flowing onto Michigan Street. There are two inbound ticketing booths at the third floor entrance and pay booths at each level to expedite payment and allow for appropriate stacking. Public and hotel self parking are on levels four through seven with valet parking on levels three and eight. Several elevators and stairwells are located on either side of the garage on these side streets for convenient access to on-site amenities and the beach.

FINDING: Consistent.

CRITERION 2: Compatibility. The relationship between existing architectural styles and proposed construction, including how each building along the street relates to the whole and the pattern created with adjacent structures and the surrounding neighborhood. Buildings should contain architectural details that are characteristic of the surrounding neighborhood.

ANALYSIS: The Design Guidelines indicate *new construction should differentiate itself from neighboring buildings in terms of architectural style while the scale, rhythm, height and setbacks as well as the location of windows, doors and balconies bear some relationship to neighboring buildings and maintain some resemblance of compatibility.*

"As previously noted, the architectural style of the building is Caribbean/West Indies which is relatively new and distinct in this area of the beach, thus differentiating itself from neighboring buildings. The proposed architectural elements, such as soft pastel aluminum railings, different types of stucco finishes, the use of Bahamian shutters and native landscaping are compatible with design quality of the building and consisting with adjacent and neighboring properties in the area. The proposed colors for the building consist of popular gray, snowfall white,

slate blue, beige (tabby coquina stucco) and silver – all of which are consistent with surrounding properties,” expresses the applicant.

Other than the flexible nature of GU zoning, the expansive 5 acre lot gives way to room for additional plasticity in relation to scale. Additionally, the building was designed with most its massing toward the western portion of the property (123' setback) to soften its impact on the beach and buildings lining the Broadwalk. Extending active uses on smaller scale (50') toward the Broadwalk creates a higher level of compatibility that would not otherwise be achieved. This building's scale and architectural features add a break in the current pattern buildings, create a needed focal for the Broadwalk, and a point of interest for tourists and local beachgoers.

FINDING: Consistent.

CRITERION 3: Scale/Massing. Buildings shall be proportionate in scale, with a height which is consistent with the surrounding structures. Building mass shall reflect a simple composition of basic architectural details in relation to its length, width, height, lot coverage, and setting of the structure in context with adjacent buildings. Architectural details include, but are not limited to, banding, molding, and fenestration.

ANALYSIS: For buildings along the Intracoastal and other highly visible frontages, the Design Guidelines recommend *buildings be designed with a distinctive form*. They go on to say *stepped form and distinctive rooflines create a more interesting skyline and increase building recognition*. These elements form an interesting design and also help to create needed breaks in massing.

The east parcel encompasses a variety of setbacks at different levels of the building. Overall, the building will be 17 stories, 209' feet tall at its highest architectural element. Along A1A the building pedestal will be approximately 40' tall at a setback of 29'-98' where a water entry feature and porte-cochere are located. As previously mentioned, it was designed with most of its massing on the western portion of the property toward A1A. Subsequently, following a setback ranging from 123'-152' from the Broadwalk, the building continues to step back from the beach as the height increases. This softens its impact on the beach while still interacting with the environment and attracting pedestrians. Within the setback area will be a Lagoon pool, Volcano Water Slide pool, Ridin' In Style wave simulation pool, Lone Palm Bar, Air Stream Bar, and Captain Tony's Pizza Shack snack bar.

A reduction in massing is further achieved through a horse shoe shape which begins at the eleventh floor and continues upward. Though less dramatic, a similar feature is used on along A1A creating an additional setback beginning at the fourth floor. As various fluctuations vertical

plains, undulations in the building façade and contrasting materials and finishes all help to reduce the overall building mass.

The applicant further explains, "The building has been designed to avoid the appearance of a continuous sheer wall through the use of decorative surfaces and elements, multilevel decks (particularly from the east elevation with the use of the event lawn), water features, and sufficient setbacks. The project provides the City with a world class resort style hotel and convention center in a manner which is not only to scale with surrounding properties, but also minimizes any effects of massing through the building design and setbacks."

FINDING: Consistent.

CRITERION 4: Landscaping. Landscaped areas should contain a variety of native and other compatible plant types and forms, and be carefully integrated with existing buildings and paved areas. Existing mature trees and other significant plants on the site should be preserved.

ANALYSIS: The applicant states, "All plantings designed accentuate the feeling that the beach extends directly into the project, as one of the key aspects of a Margaritaville resort destination is the beach itself. Trees, shrubs and other plantings have been arranged around all pools and decks to provide for appropriate shading. Particular care has been taken to use landscaping as an effective tool to reduce the impact of the building footprint with adjacent properties, while encouraging pedestrian use."

Native and exotic plantings such as Royal Palms, Gumbo Limbo, Live Oak, Giant Bird of Paradise and Foxtail Palms along with wide array of other materials will be used to create a lush landscape design. Additionally, Bougainvillea will line the east and west elevation on the parking levels acting as a shield for this use and softening the building overall. The City's Design Review Manual recommends *highlighting architectural elements with a dark contrasting color as compared to the main color*. While the building colors are of light shades of blue, beige and grey, decorative elements such as aluminum and greenery will be used to compliment and contrast the building's features.

A variety of mostly palms and small number of trees exist on the site, some of which are in fair condition, while others are in good condition. The developer will work with the City for removal, relocation and replacement of all trees.

FINDING: Consistent.

SITE PLAN

A final site plan was reviewed by the Technical Advisory Committee (TAC) and comments were made by members of the TAC in a staff report dated October 18, 2010. The comments were addressed by the applicant, who then obtained the signature of each TAC member signifying the site plan's compliance with all regulations as set forth in Chapter 162 of the Hollywood Code of Ordinances.

Due to the Government Use zoning for this site, the task of Site Plan approval lies with the City Commission. Therefore, the Development Review Board will forward a recommendation to the City Commission for this item, if Design is granted.

RECOMMENDATION

Variance

Staff finds the requests to be consistent with all specified criteria and thereby recommends approval of the requested Variance, subject to any changes the City Commission may deem necessary while considering the Site Plan.

Design

Staff finds the request for Design Review consistent with all specified criteria and therefore recommends approval subject to any changes the City Commission may deem necessary when considering the Site Plan.

Site Plan

The Technical Advisory Committee (TAC) found the Site Plan substantially compliant with all applicable regulations and therefore recommends the ***Development Review Board forward a recommendation of approval to the City Commission if Design is granted.***

ATTACHMENTS

ATTACHMENT A: Application Package
ATTACHMENT B: Margaritaville Signage
ATTACHMENT C: Land Use & Zoning Map

Attachment A

Application Package

OFFICE OF PLANNING



File No. (to be filled by the Office of Planning): _____

2600 Hollywood Boulevard Room 315
Hollywood, FL 33022

GENERAL APPLICATION



Tel: (954) 921-3471
Fax: (954) 921-3347

This application must be completed in full and submitted with all documents to be placed on a Board or Committee's agenda.

The applicant is responsible for obtaining the appropriate checklist for each type of application.

Applicant(s) or their authorized legal agent must be present at all Board or Committee meetings.

At least one set of the submitted plans for each application must be signed and sealed (i.e. Architect or Engineer).

Documents and forms can be accessed on the City's website at

http://www.hollywoodfl.org/comm_planning/appforms.htm



APPLICATION TYPE (CHECK ONE):

- ☒ Development Review Board ☐ Historic Preservation Board
☒ Planning and Zoning Board ☐ Technical Advisory Committee
☐ City Commission

Date of Application: October 29, 2010Location Address: 300 Johnson Street, Hollywood, FloridaLot(s): See attached legal Block(s): See attached Subdivision: See attached legalFolio Number(s): 541213010010, 514213010700, 514213010701Zoning Classification: GU-Government Use Land Use Classification: Municipal Use, OtherExisting Property Use: Parking Garage/Lot Sq Ft/Number of Units: N/A

Is the request the result of a violation notice? () Yes (✓) No If yes, attach a copy of violation.

Has this property been presented to the City before? If yes, check all that apply and provide File Number(s) and Resolution(s): 10-DP-42

- ☒ Economic Roundtable ☒ Technical Advisory Committee ☐ Development Review Board
☐ Planning and Zoning Board ☐ Historic Preservation Board ☐ City Commission

Explanation of Request: DRB and P&Z Site Plan review for the development known as
Margaritaville Hollywood Beach Resort

Number of units/rooms: 349 Sq Ft: 848,030Value of Improvement: \$100 million Estimated Date of Completion: October 2013

Will Project be Phased? () Yes (✓) No If Phased, Estimated Completion of Each Phase

Name of Current Property Owner: City of Hollywood, Office of Business and Intl TradeAddress of Property Owner: 2600 Hollywood Blvd., Hollywood, Florida 33020-4807Telephone: 954-921-3474 Fax: _____ Email Address: _____Name of Consultant/Representative (circle one): Margaritaville Hillywd Bch Rsrt LLCAddress: 3501 N. Ocean Drive, Hollywood, FL 33019 Telephone: 954-922-6466Fax: 954-922-8988 Email Address: lont@lojeta.comDate of Purchase: N/A Is there an option to purchase the Property? Yes () No (✓)

If Yes, Attach Copy of the Contract.

List Anyone Else Who Should Receive Notice of the Hearing: Wilson C. Atkinson, III, Esq.Atkinson, Diner, Stone, et al. Address: 100 SE 3rd Ave, Suite 1400Ft. Lauderdale, FL 33394 Email Address: wca@atkinson-diner.com

(Authorized Representative of Tenant)

OFFICE OF PLANNING



2600 Hollywood Boulevard Room 315
Hollywood, FL 33022

GENERAL APPLICATION

CERTIFICATION OF COMPLIANCE WITH APPLICABLE REGULATIONS

The applicant/owner(s) signature certifies that he/she has been made aware of the criteria, regulations and guidelines applicable to the request. This information can be obtained in Room 315 of City Hall or on our website at www.hollywoodfl.org. The owner(s) further certifies that when required by applicable law, including but not limited to the City's Zoning and Land Development Regulations, they will post the site with a sign provided by the Office of Planning. The owner(s) will photograph the sign the day of posting and submit photographs to the Office of Planning as required by applicable law. Failure to post the sign will result in violation of State and Municipal Notification Requirements and Laws.

(I)(We) certify that (I) (we) understand and will comply with the provisions and regulations of the City's Zoning and Land Development Regulations, Design Guidelines, Design Guidelines for Historic Properties and City's Comprehensive Plan as they apply to this project. (I)(We) further certify that the above statements and drawings made on any paper or plans submitted herewith are true to the best of (my)(our) knowledge. (I)(We) understand that the application and attachments become part of the official public records of the City and are not returnable.

Signature of Current Owner: _____

Date: 10/26/10

PRINT NAME: Cameron D. Benson, City Manager

Date: _____

Signature of Consultant/Representative: Referring for

Date: 10/27/10

PRINT NAME: Wilson C. Atkinson, III, Esq.

Date: _____

Signature of Tenant: [Signature]

Date: 10/27/10

PRINT NAME: Lon Tabatchnick, as Manager, Margaritaville Hollywood Beach Resort, LLC

Date: _____

CURRENT OWNER POWER OF ATTORNEY

I am the current owner of the described real property and that I am aware of the nature and effect the request for (project description) _____ to my property, which is hereby made by me or I am hereby authorizing (name of the representative) _____ to be my legal representative before the _____ (Board and/or Committee) relative to all matters concerning this application.

Sworn to and subscribed before me
this _____ day of _____

SIGNATURE OF CURRENT OWNER

Notary Public State of Florida

PRINT NAME

My Commission Expires: _____ (Check One) _____ Personally known to me; OR _____

Legal Description
For Property to be Developed as Margaritaville Hollywood Beach Resort

Lots 2, 3, 5 and 6, LESS the East 12.50 feet thereof, of Block "A", "HOLLYWOOD BEACH", according to the plat thereof recorded in Plat Book 1, Page 27 of the Public Records of Broward County, Florida; and subject to a right-of-way reserve area unto the owner across the West 10 feet of the East 22.5 feet of said Lots;

Together with:

Lots 4, LESS the East 12.50 feet thereof of Block "A", "HOLLYWOOD BEACH", according to the plat thereof recorded in Plat Book 1, Page 27, of the Public Records of Broward County, Florida; and subject to a right-of-way reserve area unto the owner across the West 10 feet of the East 22.5 feet of said Lot 4; and subject to a utility reserve area unto owner across all of said Lot 4 LESS the East 12.5 feet thereof;

AND: Block "F"

Block "F", LESS the West 12.5 feet and LESS the North 40.00 feet thereof, "HOLLYWOOD BEACH", according to the plat thereof as recorded in Plat Book 1, Page 27 of the Public Records of Broward County, Florida and subject to a right-of-way reserve area unto the owner across the East 10 feet of the West 22.5 feet of said Block "F"; and subject to a utility reserve area unto owner across the East 20 feet of the West 32.5 feet LESS the South 60 feet of the North 100 feet thereof, and the South 20 feet of said Block "F".

Uses within the utility and right-of-way reserve areas shall be subject to specific approval from the owner and generally shall be limited to walkways, landscaping, signage, lighting and other similar elements consistent with utility and right-of-way uses.

Said lands situate, lying and being in the City of Hollywood, Broward County, Florida, and containing 223,439 square feet or 5.1295 acres more or less.

Folio Number(s): 514213010010, 514213010700, 514213010701

ATKINSON, DINER, STONE, MANKUTA & PLOUCHA, P.A.

ATTORNEYS AT LAW
ONE FINANCIAL PLAZA
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SUITE 1400
FT. LAUDERDALE, FL 33394-0030
WWW.ATKINSON-DINER.COM

J. KYLE HOOPER
jkh@atkinson-diner.com

BROWARD: (954) 925-5501 ext. 1324
MIAMI-DADE: (305) 944-1882 ext. 1324
FAX: (954) 920-2711

October 29, 2010

Via Hand Delivery

Development Review Board
c/o Leander Hamilton
2600 Hollywood Boulevard, Room 315
Hollywood, Florida 33022-9045

Planning and Zoning Board
c/o Leander Hamilton
2600 Hollywood Boulevard, Room 315
Hollywood, Florida 33022-9045

**Re: Project Summary for Margaritaville Hollywood Beach Resort
File No. 10-DP-42**

Dear Members of the Development Review and Planning & Zoning Boards:

As part of the DRB and P&Z applications submitted by this office on behalf of our client, Margaritaville Hollywood Beach Resort, LLC, for the upcoming joint hearing scheduled to occur on November 18, 2010, we wanted to provide you with a brief project overview outlining some of the key elements of the development while you are reviewing the attached plans.

As a destination resort and entertainment center, Margaritaville consists of a 349 room resort hotel, with a marquee entrance on Ocean Drive accentuated with lush tropical plantings and a water feature. The hotel includes a convention/conference area of approximately 30,300 sq. ft. capable of seating 2,300 persons, two outdoor pools and deck areas of approximately 58,330 sq. ft., an upscale restaurant with outdoor deck of approximately 8,500 sq. ft., and the legendary Margaritaville Restaurant of approximately 17,000 sq. ft. capable of seating 400 people. The resort also includes a full service spa and fitness area of approximately 15,500 sq. ft.


Margaritaville houses a parking facility of approximately 374,245 sq. ft. entirely enclosed within the center of the resort and hidden from view with decorative architectural elements, as well as live foliage. The parking facility consists of 1,056 parking spaces, of which 600 spaces are open to the public and the remaining spaces are for hotel guests and employees. Three separate elevators in the garage provide for direct access to Johnson Street and the beach. The project is specifically designed to allow patrons to walk from the garage to the beach and those strolling along the Boardwalk to take advantage of food, beverage and entertainment without having to enter the resort.

Beachgoers can eat at several of the resort's restaurants and bars located along the Boardwalk and Johnson Street, including the Lone Palm Bar, the Air Stream, and the Pizza Shack. The resort also

features a Flow-Rider surfing machine which the public can access and enjoy directly from the Broadwalk without being a hotel guest.

While this overview provides only a summary of some of the resort's design features and attractions, a careful review of the plans will demonstrate that Margaritaville creates a whole entertainment village for not only Hollywood residents, but all beach patrons, creating an entertainment village that will support local beach businesses as well as attract new vibrant commercial offerings. We welcome any comments that you may have.

Very truly yours,

A handwritten signature in cursive script, appearing to read "Kyle Hooper".

KYLE HOOPER

Encls.

Design Review Criteria Statement
Margaritaville Hollywood Beach Resort
File No. 10-DP-42

General Criteria. All plans/architectural drawings shall be reviewed based upon the evaluation of compatibility with the City's Design Guidelines, including the following elements:

1. Architectural and Design Components. The applicant is proposing a contemporary adaptation of the Caribbean/West Indies Style which uses architectural elements to accentuate the building's elevations and planes with a complementary palate of soft colors and textures. A few of the architectural details include: slate blue aluminum Bahamian shutters; slate blue and bright silver standing seam metal roofs; trellises holding plant materials on the east and west side of the building; soft pastel aluminum railings; stucco covered walls having the appearance of lap siding; and stucco covered walls made of crushed shells.

The City's Design Review Manual indicates that building footprints should take into account pedestrian and vehicular circulation. The design of the building allows for unencumbered pedestrian access for all public spaces, and the applicant has provided a footprint that takes into consideration for access to all public spaces. For example, the plan provides for a seamless transition for pedestrians approaching the building from the Broadwalk, with soft fences and free-form planters running along the perimeter. The lower levels include retail and restaurant space ideally situated for pedestrian access. To soften the appearance of the building at grade level, water features, planting materials, and other architectural elements are used which also act to encourage pedestrian activity at the base of the building.

The City's Design Review Manual also states that buildings should have a recognizable entrance facing the public street. This entrance should be visible to pedestrians even if vehicular entrances are located elsewhere. As currently configured, the building is pedestrian oriented with retail and restaurant space on the first floor designed with recognizable entrances. The design of the main entrance to the building's hotel located on the west elevation has a dramatic port cochere, flag poles, a water feature and native plantings.

2. Compatibility. The City of Hollywood Design Guidelines states that the surface of a building is a key factor in its appearance and relationship to adjacent buildings. The proposed architectural elements, such as soft pastel aluminum railings, different types of stucco finishes, the use of Bahamian shutters and native landscaping are compatible with design quality of the building and consistent with adjacent and neighboring properties in the area. The proposed colors for the building consist of popular gray, snowfall white, slate blue, beige (tabby coquina stucco) and silver—all of which are consistent with surrounding

properties. Pedestrian walkways are conveniently arranged connecting existing pedestrian walkways, such as those extending along A-1-A and those extending from the Broadwalk along Michigan and Johnson Streets to A-1-A. The site has specifically been designed to take advantage of the use of the band shell located toward the northeast of the property and Johnson Street has been improved to take advantage of this added attraction.

The City's Design Manual also states that new construction should differentiate itself from neighboring buildings in terms of architectural style, rhythm, height and setbacks, as well as the location of windows, doors and balconies bear some relationship to neighboring buildings and maintain some resemblance of compatibility. As previously noted, the architectural style of the building is Caribbean / West Indies which is relatively new and distinct in this area of the beach, thus differentiating itself from neighboring buildings. Yet, through the use of Bahamian-style shutters, color selection, stucco materials and other architectural design elements, the building ties nicely into the surrounding neighborhood.

3. Scale/Massing. The building has been designed to avoid the appearance of a continuous sheer wall through the use of decorative surfaces and elements, multilevel decks (particularly from the east elevation with the use of the event lawn), water features, and sufficient setbacks. The use of the porte-cochere on the west side of the building and the incorporation of the pools / events area on the east side of the building create a compatible setting as they relate to building height and scale to those surrounding properties. The project provides the City with a world class resort style hotel and convention center in a manner which is not only to scale with surrounding properties, but also minimizes any effects of massing through the building design and setbacks. Given the City's desire for a distinctive design, the building, through the use of stepped form and staggered rooflines, has a unique form creating a more interesting skyline and increased building recognition.
4. Landscaping. The City's Design Manual provides that for oceanfront projects native oceanfront species which help to retain the beach character are required. Additionally, it states that pool decks should include landscaping to provide shade and a tropical image. The project is to include an assortment of palms and other hardy, salt-tolerant/native species. The applicant will be meeting the 50% native tree requirement as provided within the landscaping plans. All existing mature trees are being preserved (to the extent possible) with the relocation of 117 trees. All plantings are designed accentuate the feeling that the beach extends directly into the project, as one of the key aspects of a Margaritaville resort destination is the beach itself. Trees, shrubs and other plantings have been arranged around all pools and decks to provide for appropriate shading. Particular care has been taken to use landscaping as an effective tool to reduce the impact of the building footprint with adjacent properties, while encouraging pedestrian use.


MARGARITAVILLE HOLLYWOOD BEACH RESORT HOLLYWOOD BEACH, FLORIDA

300 JOHNSON STREET
HOLLYWOOD, FLORIDA 33019
TAC/DRB/P&Z SET 10-29-2010



PROJECT DESIGN TEAM

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OWNER:
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BEACH RESORT, LLC
3801 N. OCEAN DRIVE
HOLLYWOOD, FLORIDA 33019

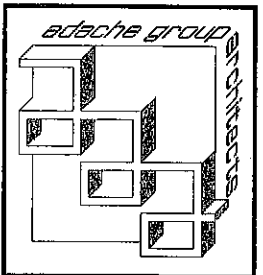

SEAL:

ISSUED FOR: TAC FINAL
DATE: 10/29/2010



No.	DATE	REMARKS

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COVER SHEET

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CHECKED BY: JB
JOB NO.: 84.08A

SHEET NO.:
A-0.0.00

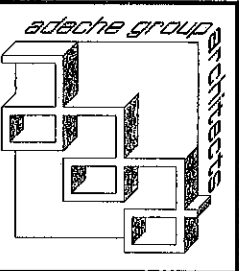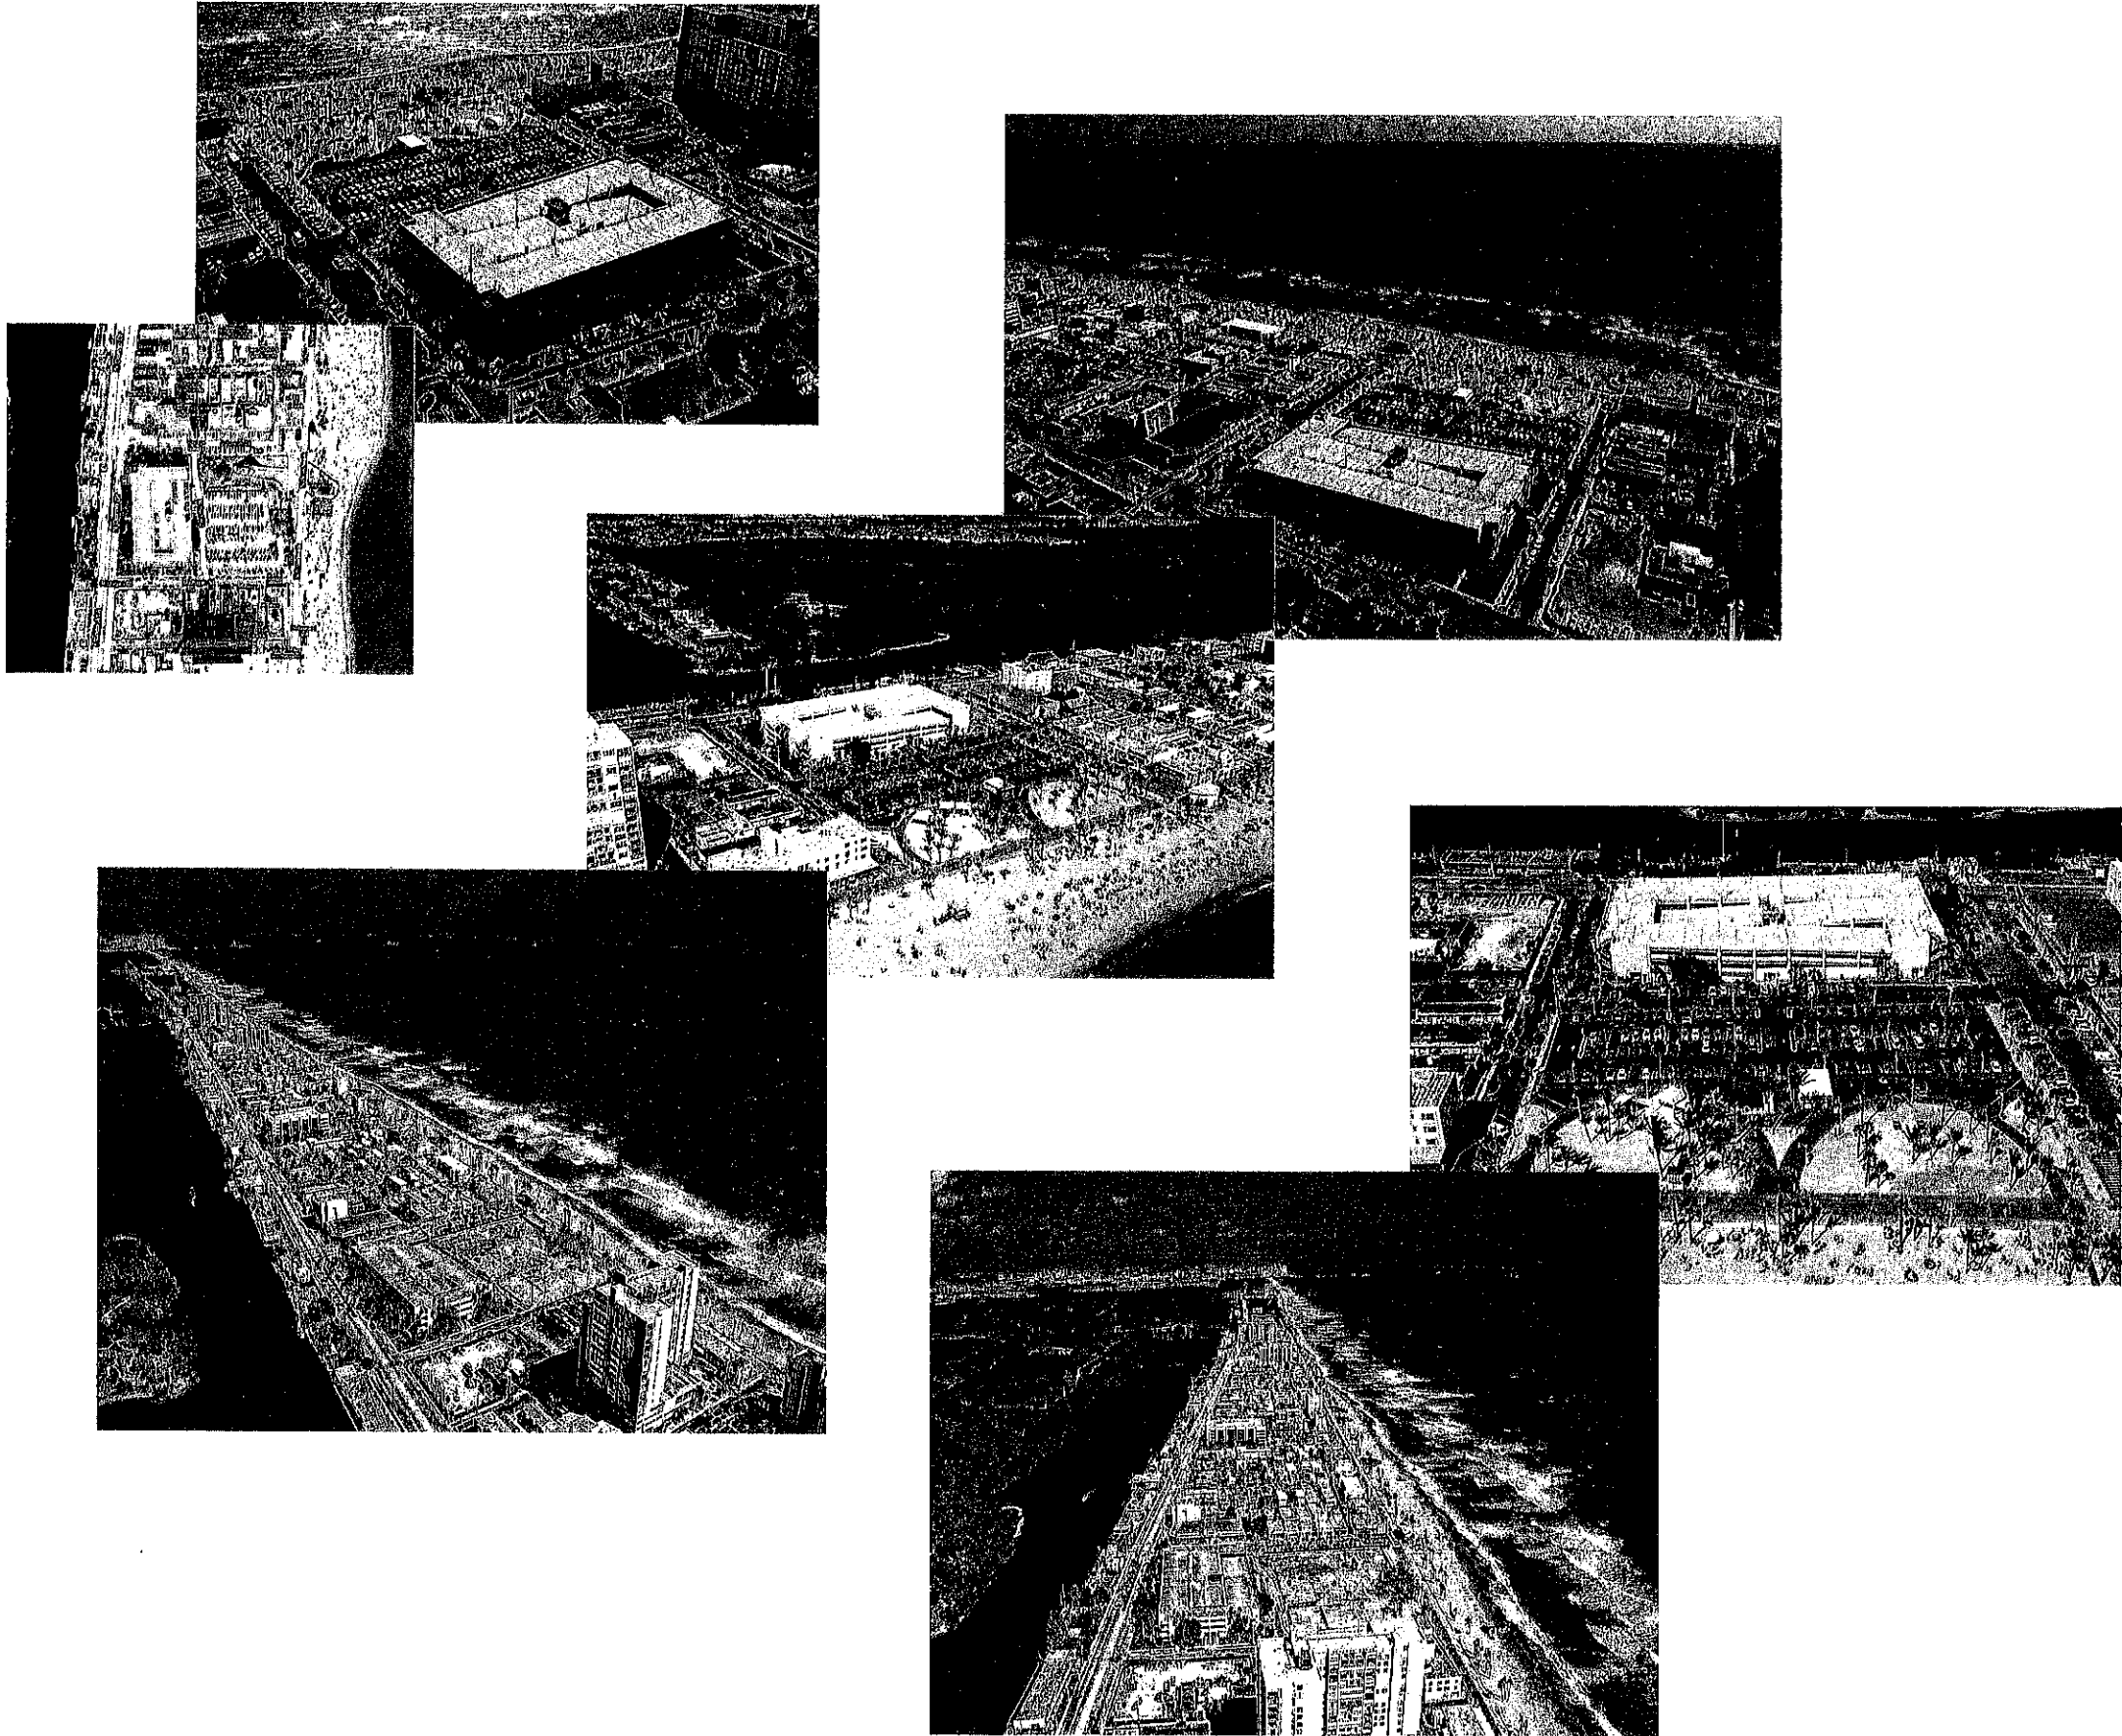

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SEAL:

ISSUED FOR: TAC FINAL
DATE: 10/28/2010

REVISIONS:		
No.	DATE	REMARKS


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SITE IMAGES

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SCALE: NA
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CHECKED BY: JB
JOB NO.: 94,08A

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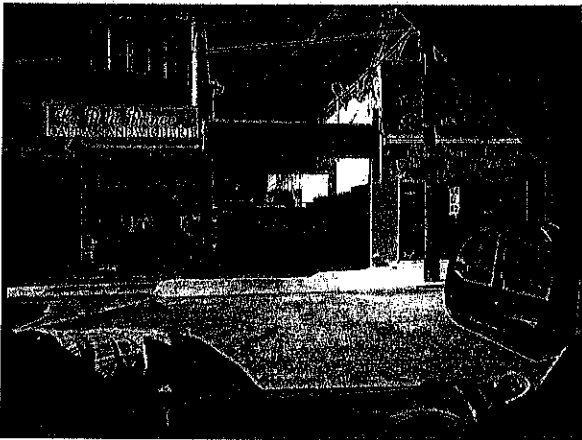
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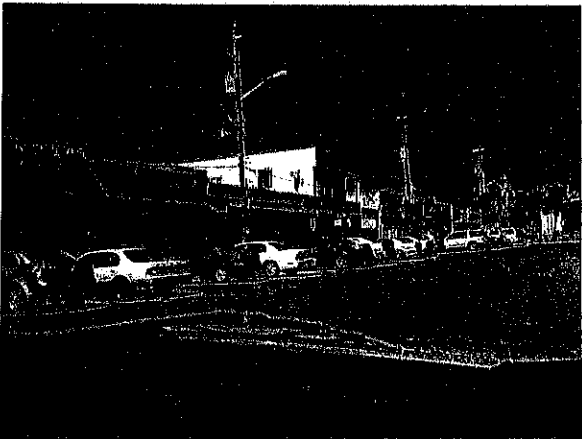
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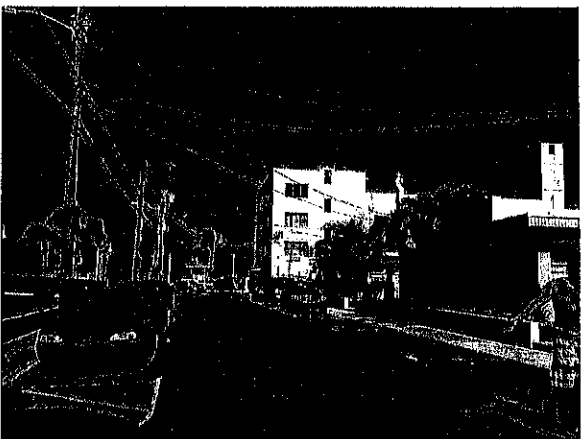
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LOOKING NORTH
(SIDE STREET)




JOHNSON STREET
LOOKING NORTHEAST

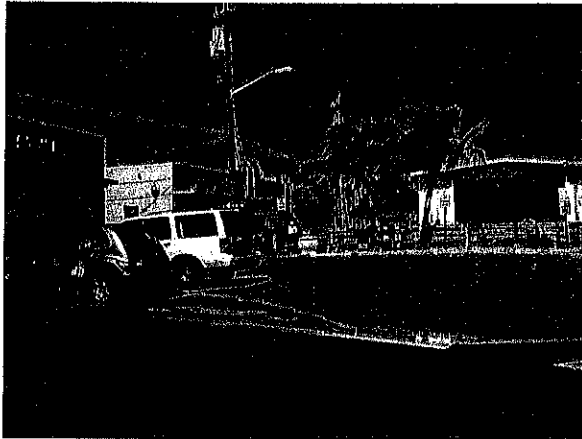

MICHIGAN STREET
LOOKING EAST



MICHIGAN STREET
LOOKING EAST

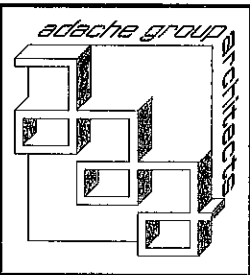

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ISSUED FOR: TAC FINAL
DATE: 10/29/2010


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JOB NO.: 94.08A

SHEET NO.:
A-0.0.04



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3501 N. OCEAN DRIVE
HOLLYWOOD, FLORIDA 33019

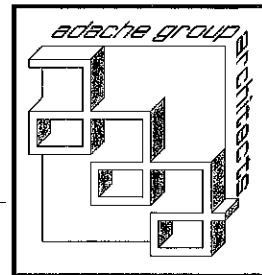

SEAL:

ISSUED FOR: TAC FINAL
DATE: 10/29/2010


REVISIONS:		
No.	DATE	REMARKS

SHEET TITLE:
SITE PLAN

ALL IDEAS, DESIGNS, ARRANGEMENTS, PLANS AND SPECIFICATIONS INDICATED OR REPRESENTED BY THIS DRAWING ARE OWNED BY, AND THE PROPERTY OF, ADACHE GROUP ARCHITECTS, INC. AND WERE CREATED, DEVELOPED AND DEVELOPED FOR USE ON, AND IN CONNECTION WITH, THE SPECIFIED PROJECT. NONE OF THESE IDEAS, PLANS, ARRANGEMENTS, AND SPECIFICATIONS SHALL BE USED BY OR FOR ANY PERSON, CORPORATION OR FIRM FOR ANY PURPOSE WHATSOEVER WITHOUT THE WRITTEN PERMISSION OF ADACHE GROUP ARCHITECTS. VISUAL CONTACT WITH THESE PLANS OR SPECIFICATIONS SHALL CONSTITUTE CONCLUSIVE EVIDENCE OF ACCEPTANCE OF THESE RESTRICTIONS. ALL RIGHTS RESERVED. © 2010
FLORIDA LICENSE #A10067073


DATE:
SCALE: 1/32"=1'-0"
DRAWN BY: EJ
CHECKED BY: JD
JOB NO.: 84.08A

SHEET NO.:
A-1.1.01

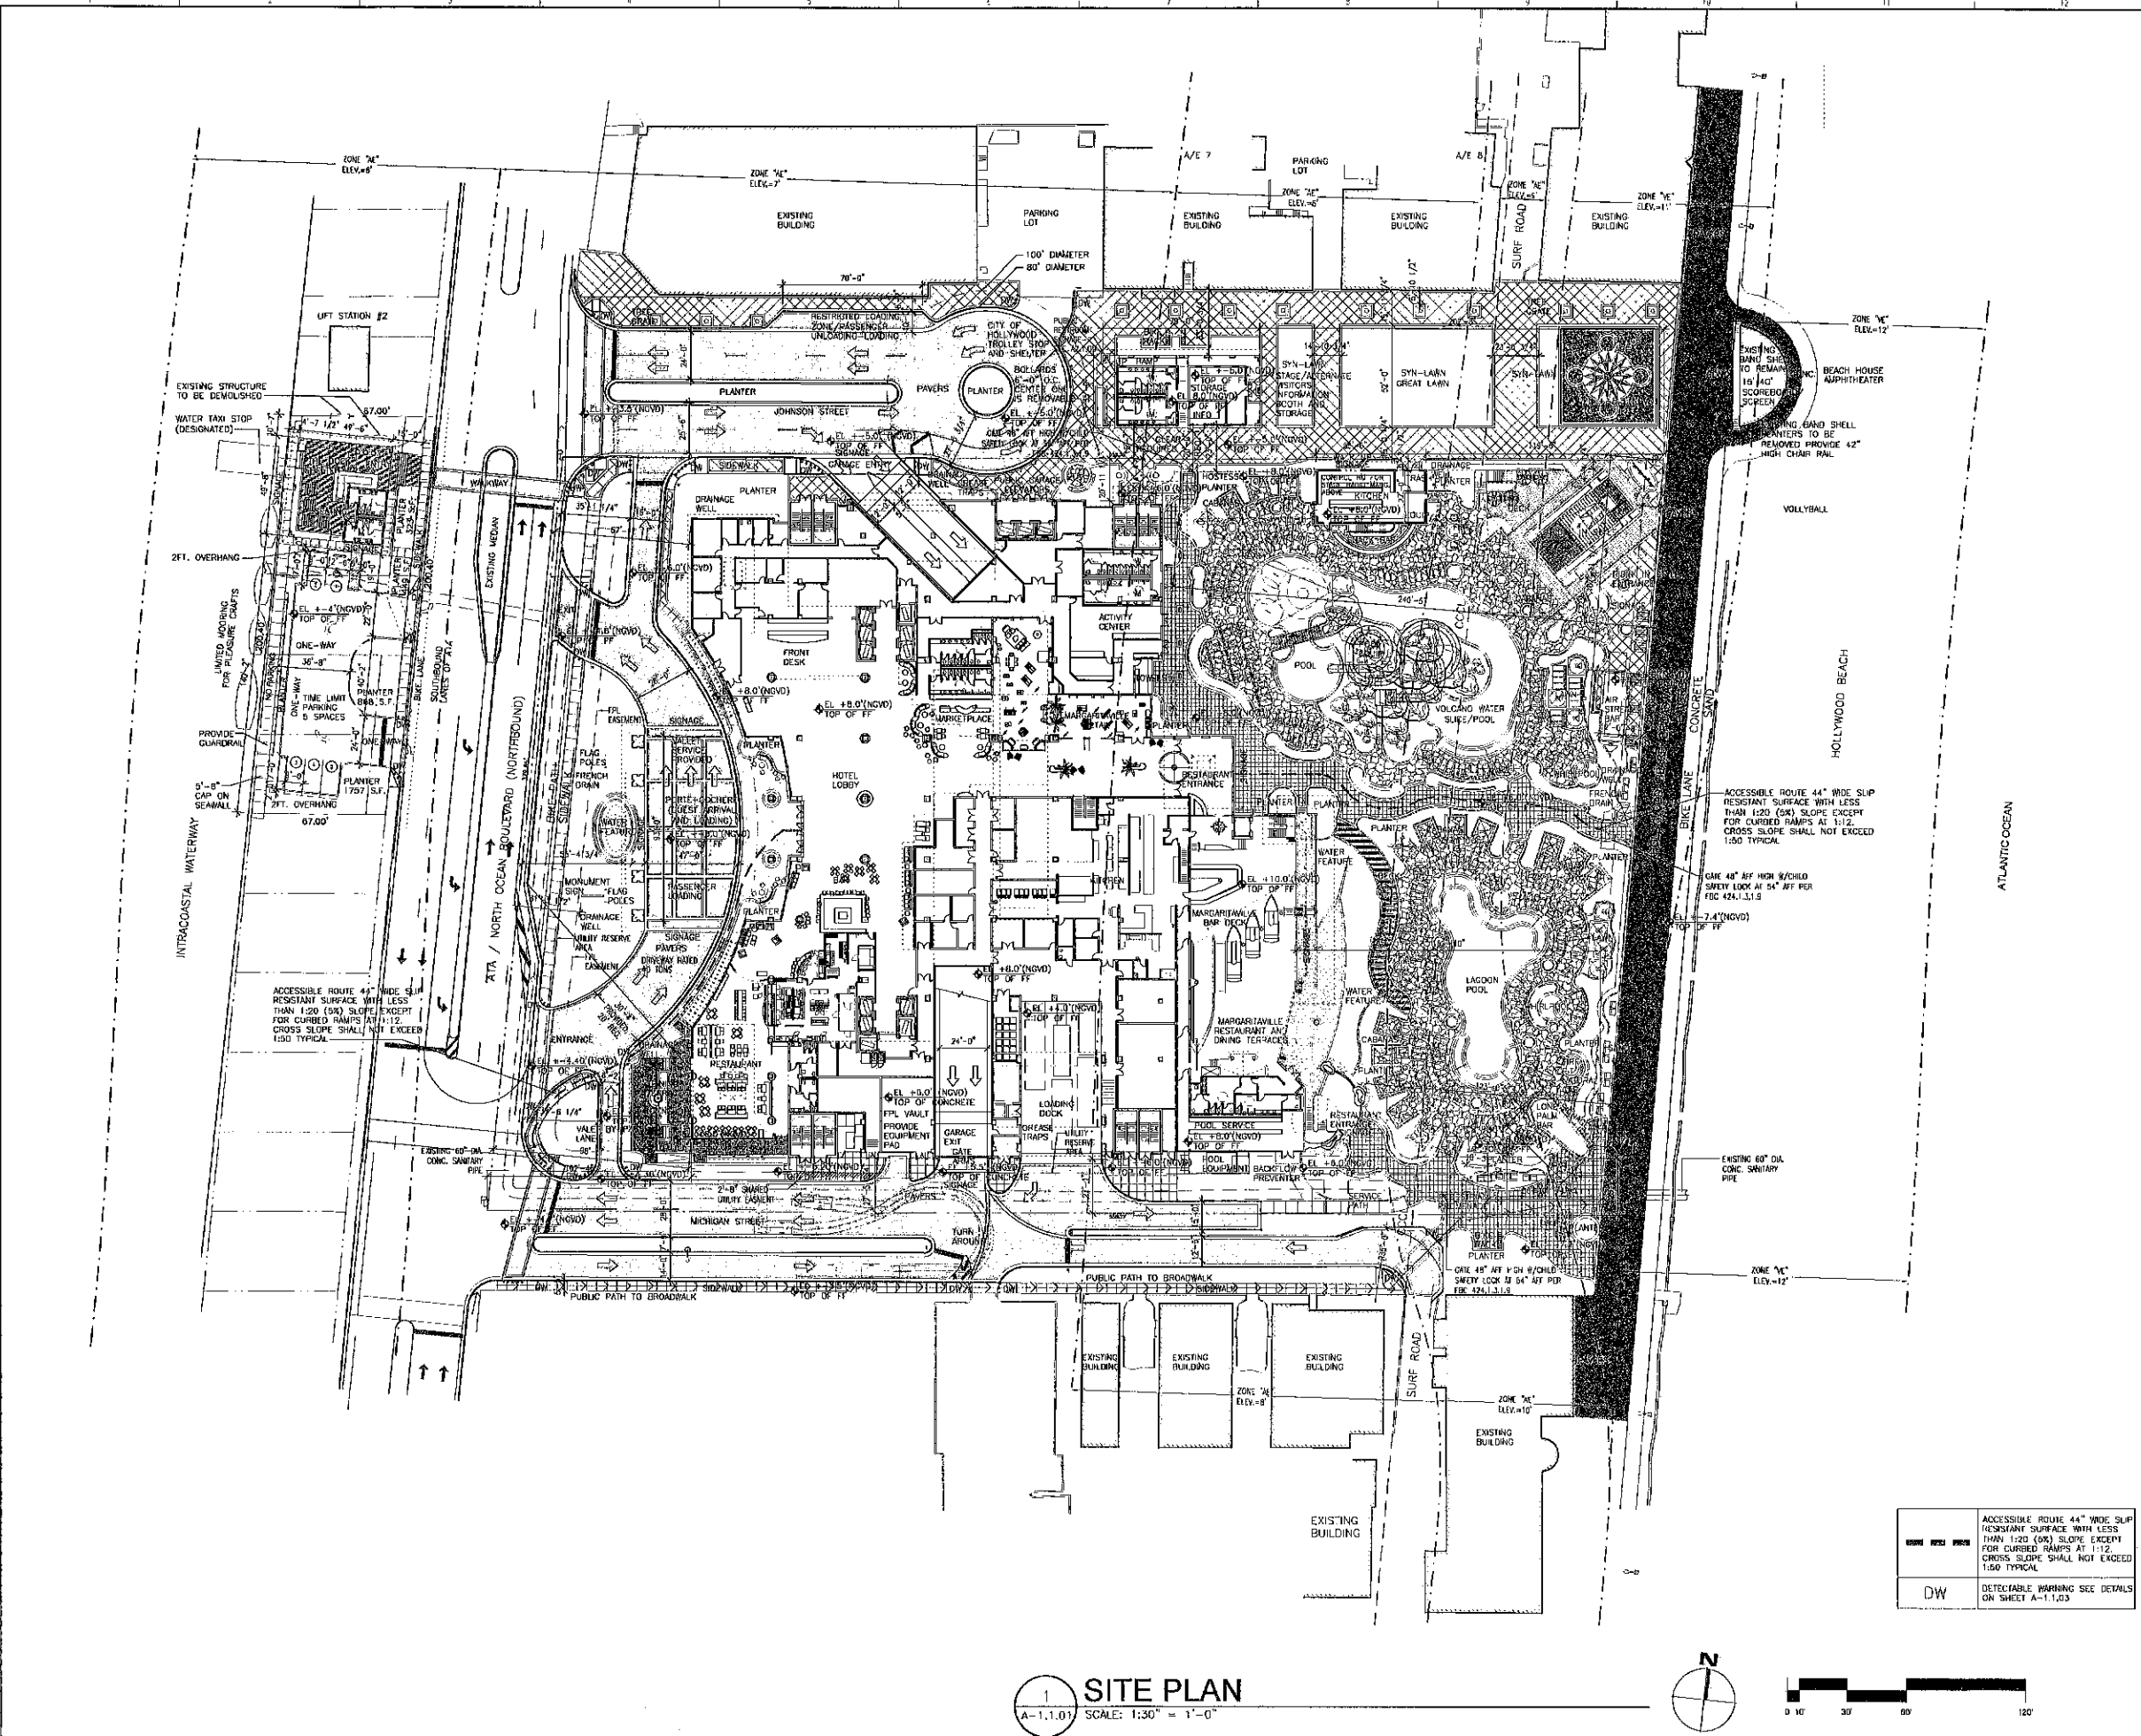


1 SITE PLAN
A-1.1.01 SCALE: 1/32" = 1'-0"



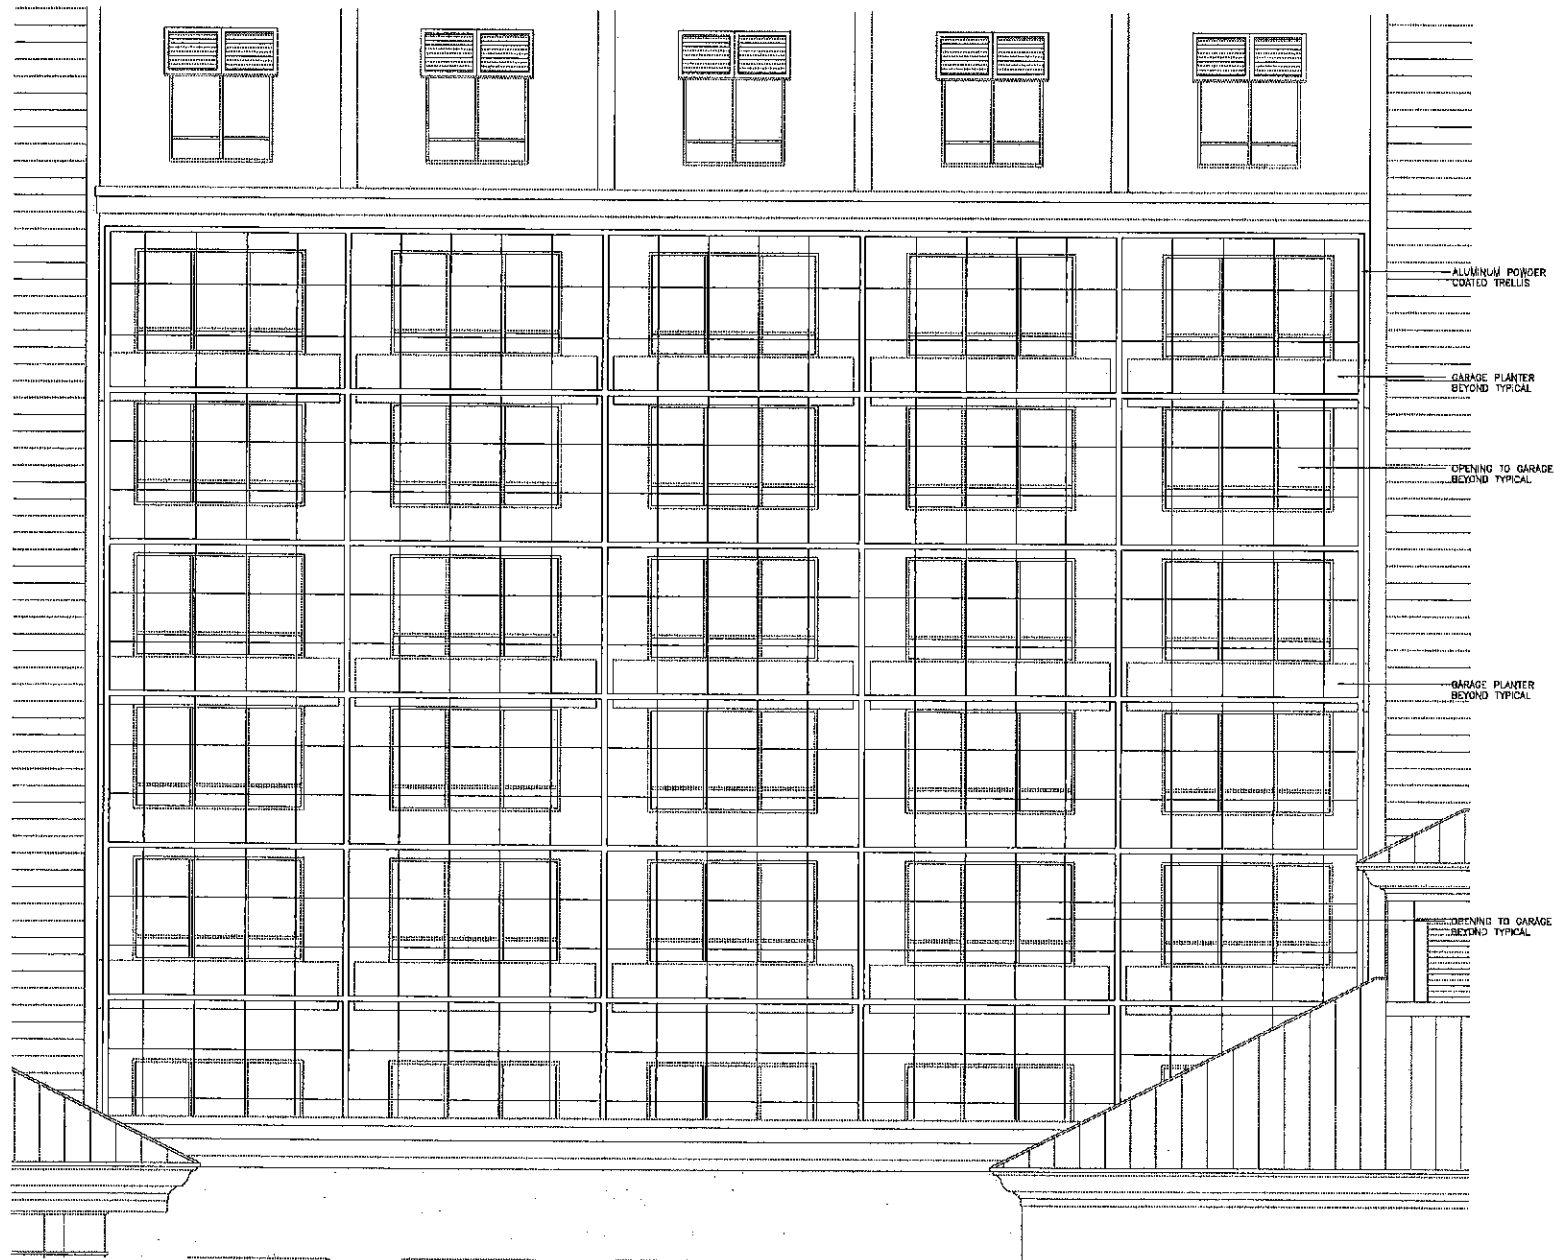


ELEVATION
TYPICAL PARKING GARAGE LANDSCAPE TRELLIS DETAIL - EAST AND WEST ELEVATIONS ONLY

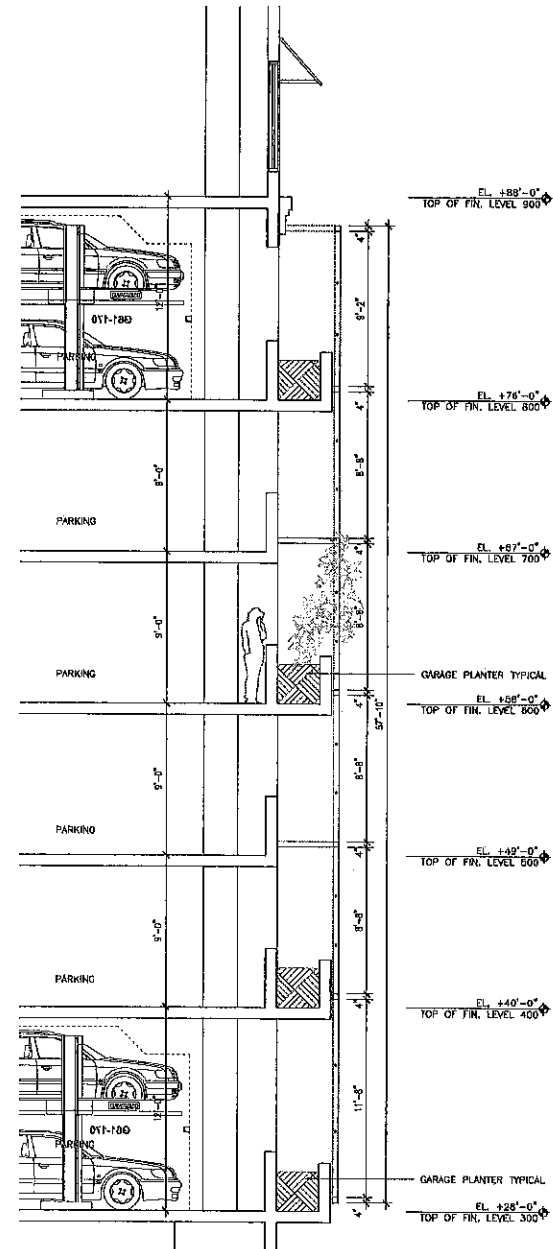

SECTION

1
A-1.1.03A SCALE: 1/4" = 1'-0"

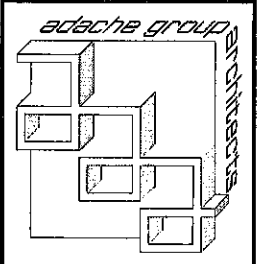

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8000 S. DIXIE AVE. SUITE 100
MIAMI, FL 33156
TEL: (305) 470-9800 FAX: (305) 470-9800
E-MAIL: info@twr-engineers.com
STRUCTURAL ENGINEER
TRC WORLDWIDE ENGINEERING
2000 NW 68 STREET
FORT LAUDERDALE, FL 33304
(561) 484-7777 FAX: (561) 484-7504
CIVIL ENGINEER
CONSULTING ENGINEERING & SCIENCE, INC.
10000 KENILWAT DRIVE, SUITE 400
MIAMI, FL 33156
(305) 470-5555 FAX: (305) 470-4888

OWNER: MARGARITAVILLE HOLLYWOOD
BEACH RESORT, LLC
3501 N. OCEAN DRIVE
HOLLYWOOD, FL 33018



SEAL:

ISSUED FOR: TAG FINAL
DATE: 10/20/2010


REVISIONS:		
No.	DATE	REMARKS

SHEET TITLE:
PARKING GARAGE
LANDSCAPE TRELLIS


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FLORIDA LICENSE # AR0007073

DATE: 10/20/2010
SCALE: 1/32" = 1'-0"
DRAWN BY: EJ
CHECKED BY: JB
JOB NO.: 94.08A


SHEET NO.:
A-1.1.03A

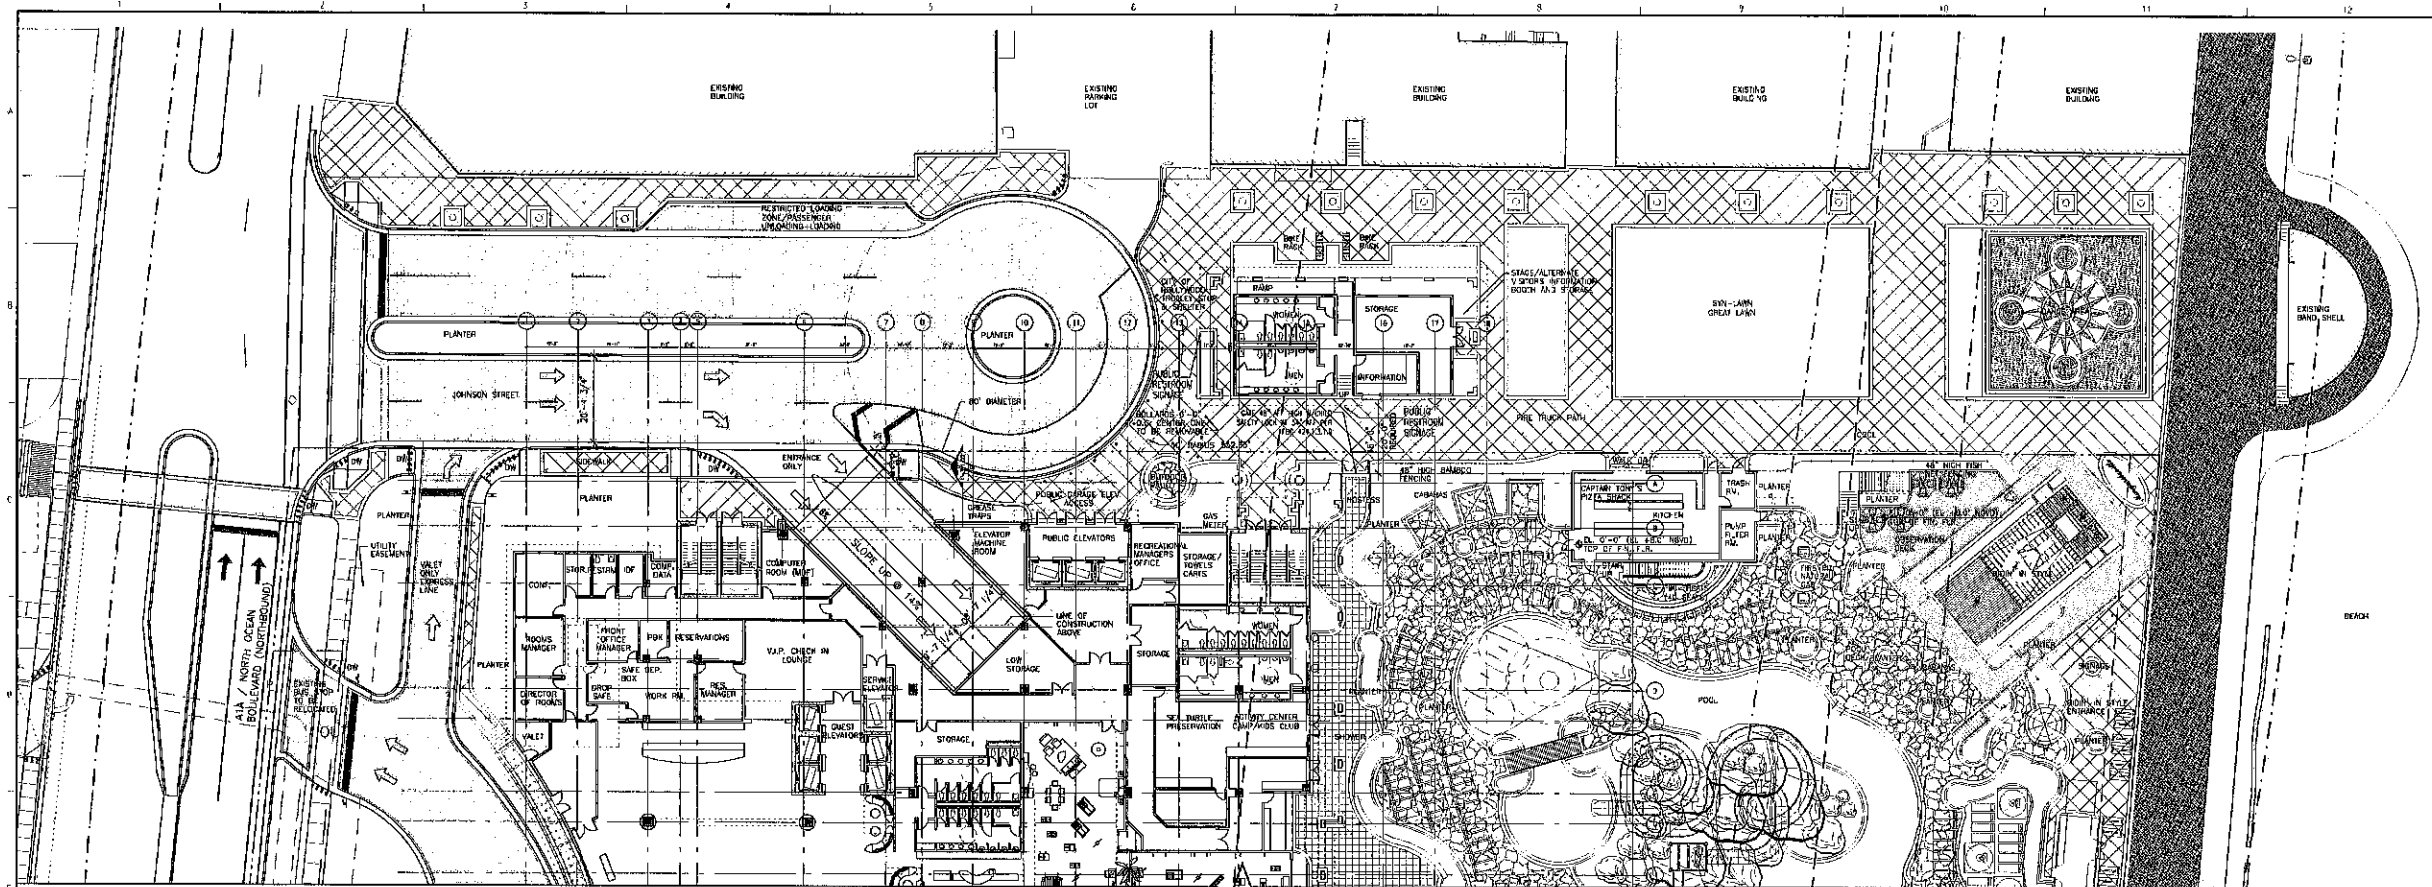


1 FLOOR PLAN-JOHNSON STREET
SCALE: 1" = 20'-0"

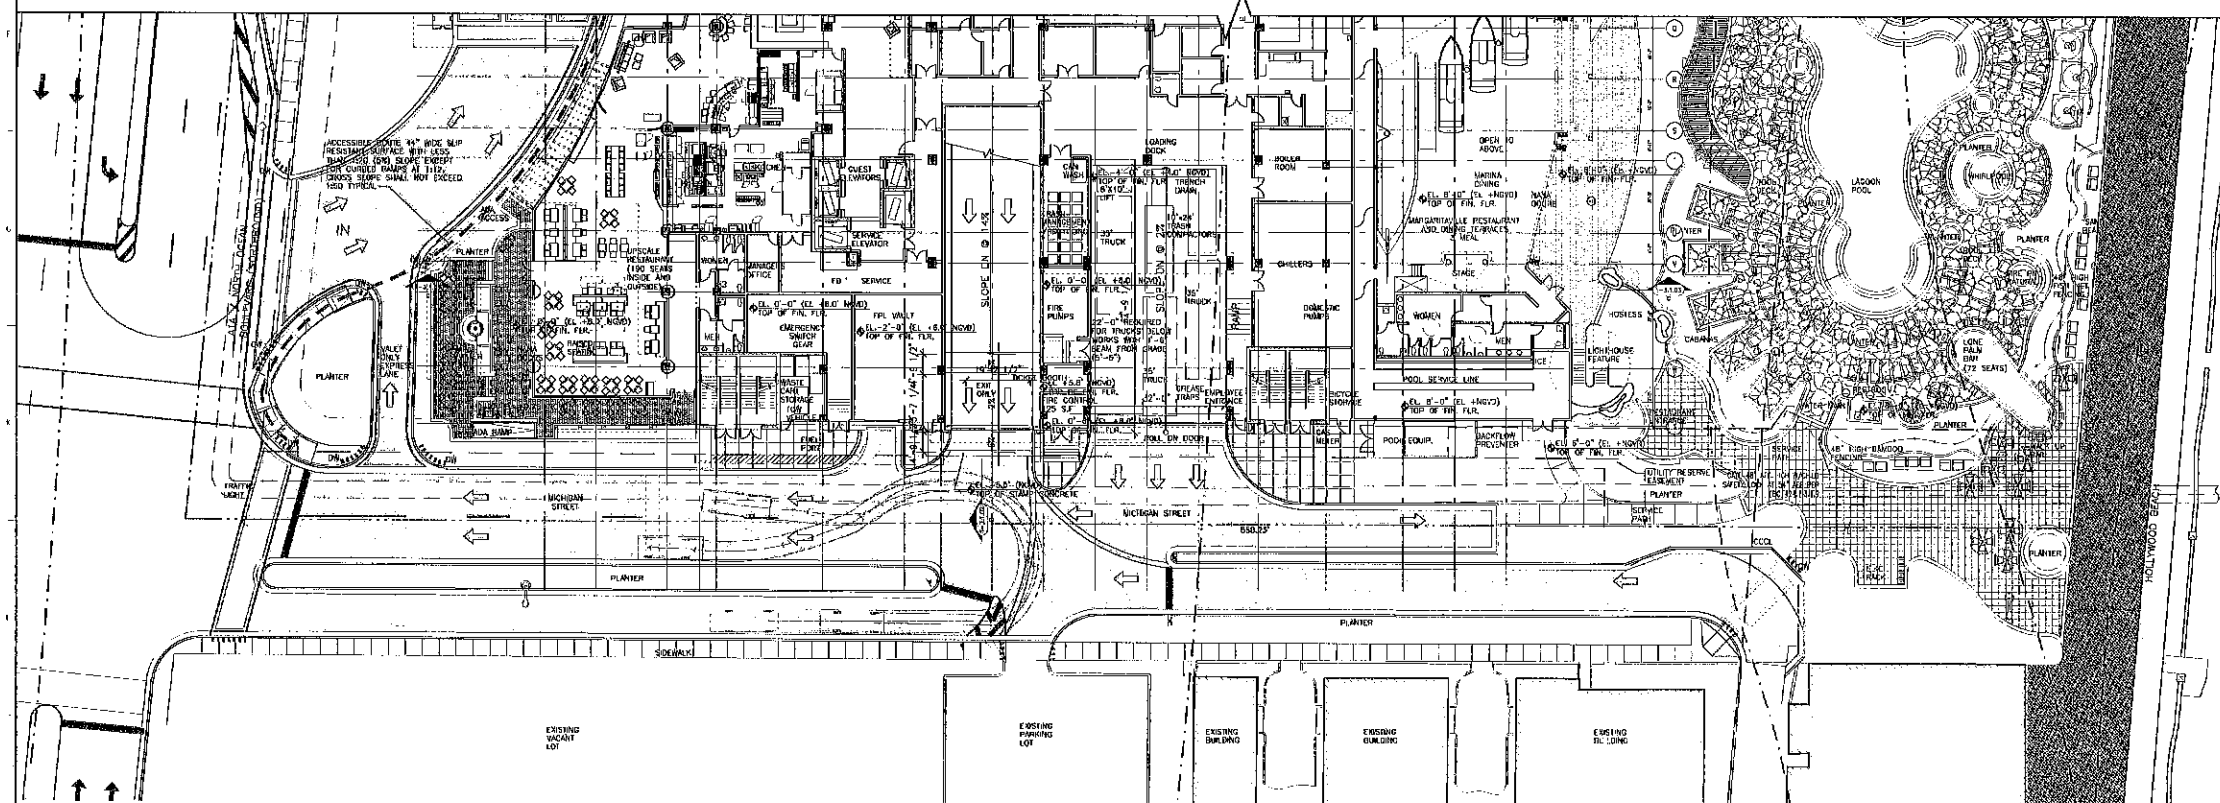

2 FLOOR PLAN-MICHIGAN STREET
SCALE: 1" = 20'-0"

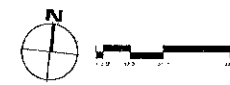

ACCESSIBLE ROUTE 44" WIDE SLIP RESISTANT SURFACE WITH LESS THAN 1:20 (5%) SLOPE EXCEPT FOR CURBED RAMPS AT 1:12. CROSS SLOPE SHALL NOT EXCEED 1:50 TYPICAL.
DW DETECTABLE WARNING SEE DETAILS ON SHEET A-1.1.03

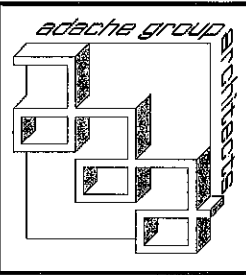

PROJECT DESIGN TEAM:
ARCHITECTS
ADACHE GROUP ARCHITECTS
400 SOUTH FEDERAL HIGHWAY #11
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11 BAKER FARM RD.
MANCHESTER CENTER, VT. 05255
PH: (802) 476-2919 FAX: (802) 345-5105
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M.E.P. ENGINEER
TWR ENGINEERS
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3001 NW 56 STREET
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PH: (954) 464-7777 FAX: (954) 464-7884
CIVIL ENGINEER
CONSULTING ENGINEERING & SCIENCE, INC.
10706 REGIONAL DRIVE SUITE 400
MIAMI, FLORIDA 33156
PH: (305) 555-1000 FAX: (305) 275-4553

OWNER: MARGARITAVILLE HOLLYWOOD
BEACH RESORT, LLC.
3501 N. OCEAN DRIVE
HOLLYWOOD, FLORIDA 33019



300 JOHNSON STREET
HOLLYWOOD BEACH, FLORIDA

SEAL:

ISSUED FOR: TAC FINAL
DATE: 10/28/2010


REVISIONS:		
No.	DATE	REMARKS

SHEET TITLE: JOHNSON/MICHIGAN
STREET FLOOR PLANS


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DATE: 10/28/2010
DRAWN BY: E.J.
CHECKED BY: J.B.
JOB NO.: 94.00A

SHEET NO.:
A-1.3.01a

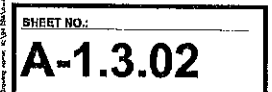

1 SECOND FLOOR SPA PLAN
A-1.3.02 SCALE: 1/16" = 1'-0"

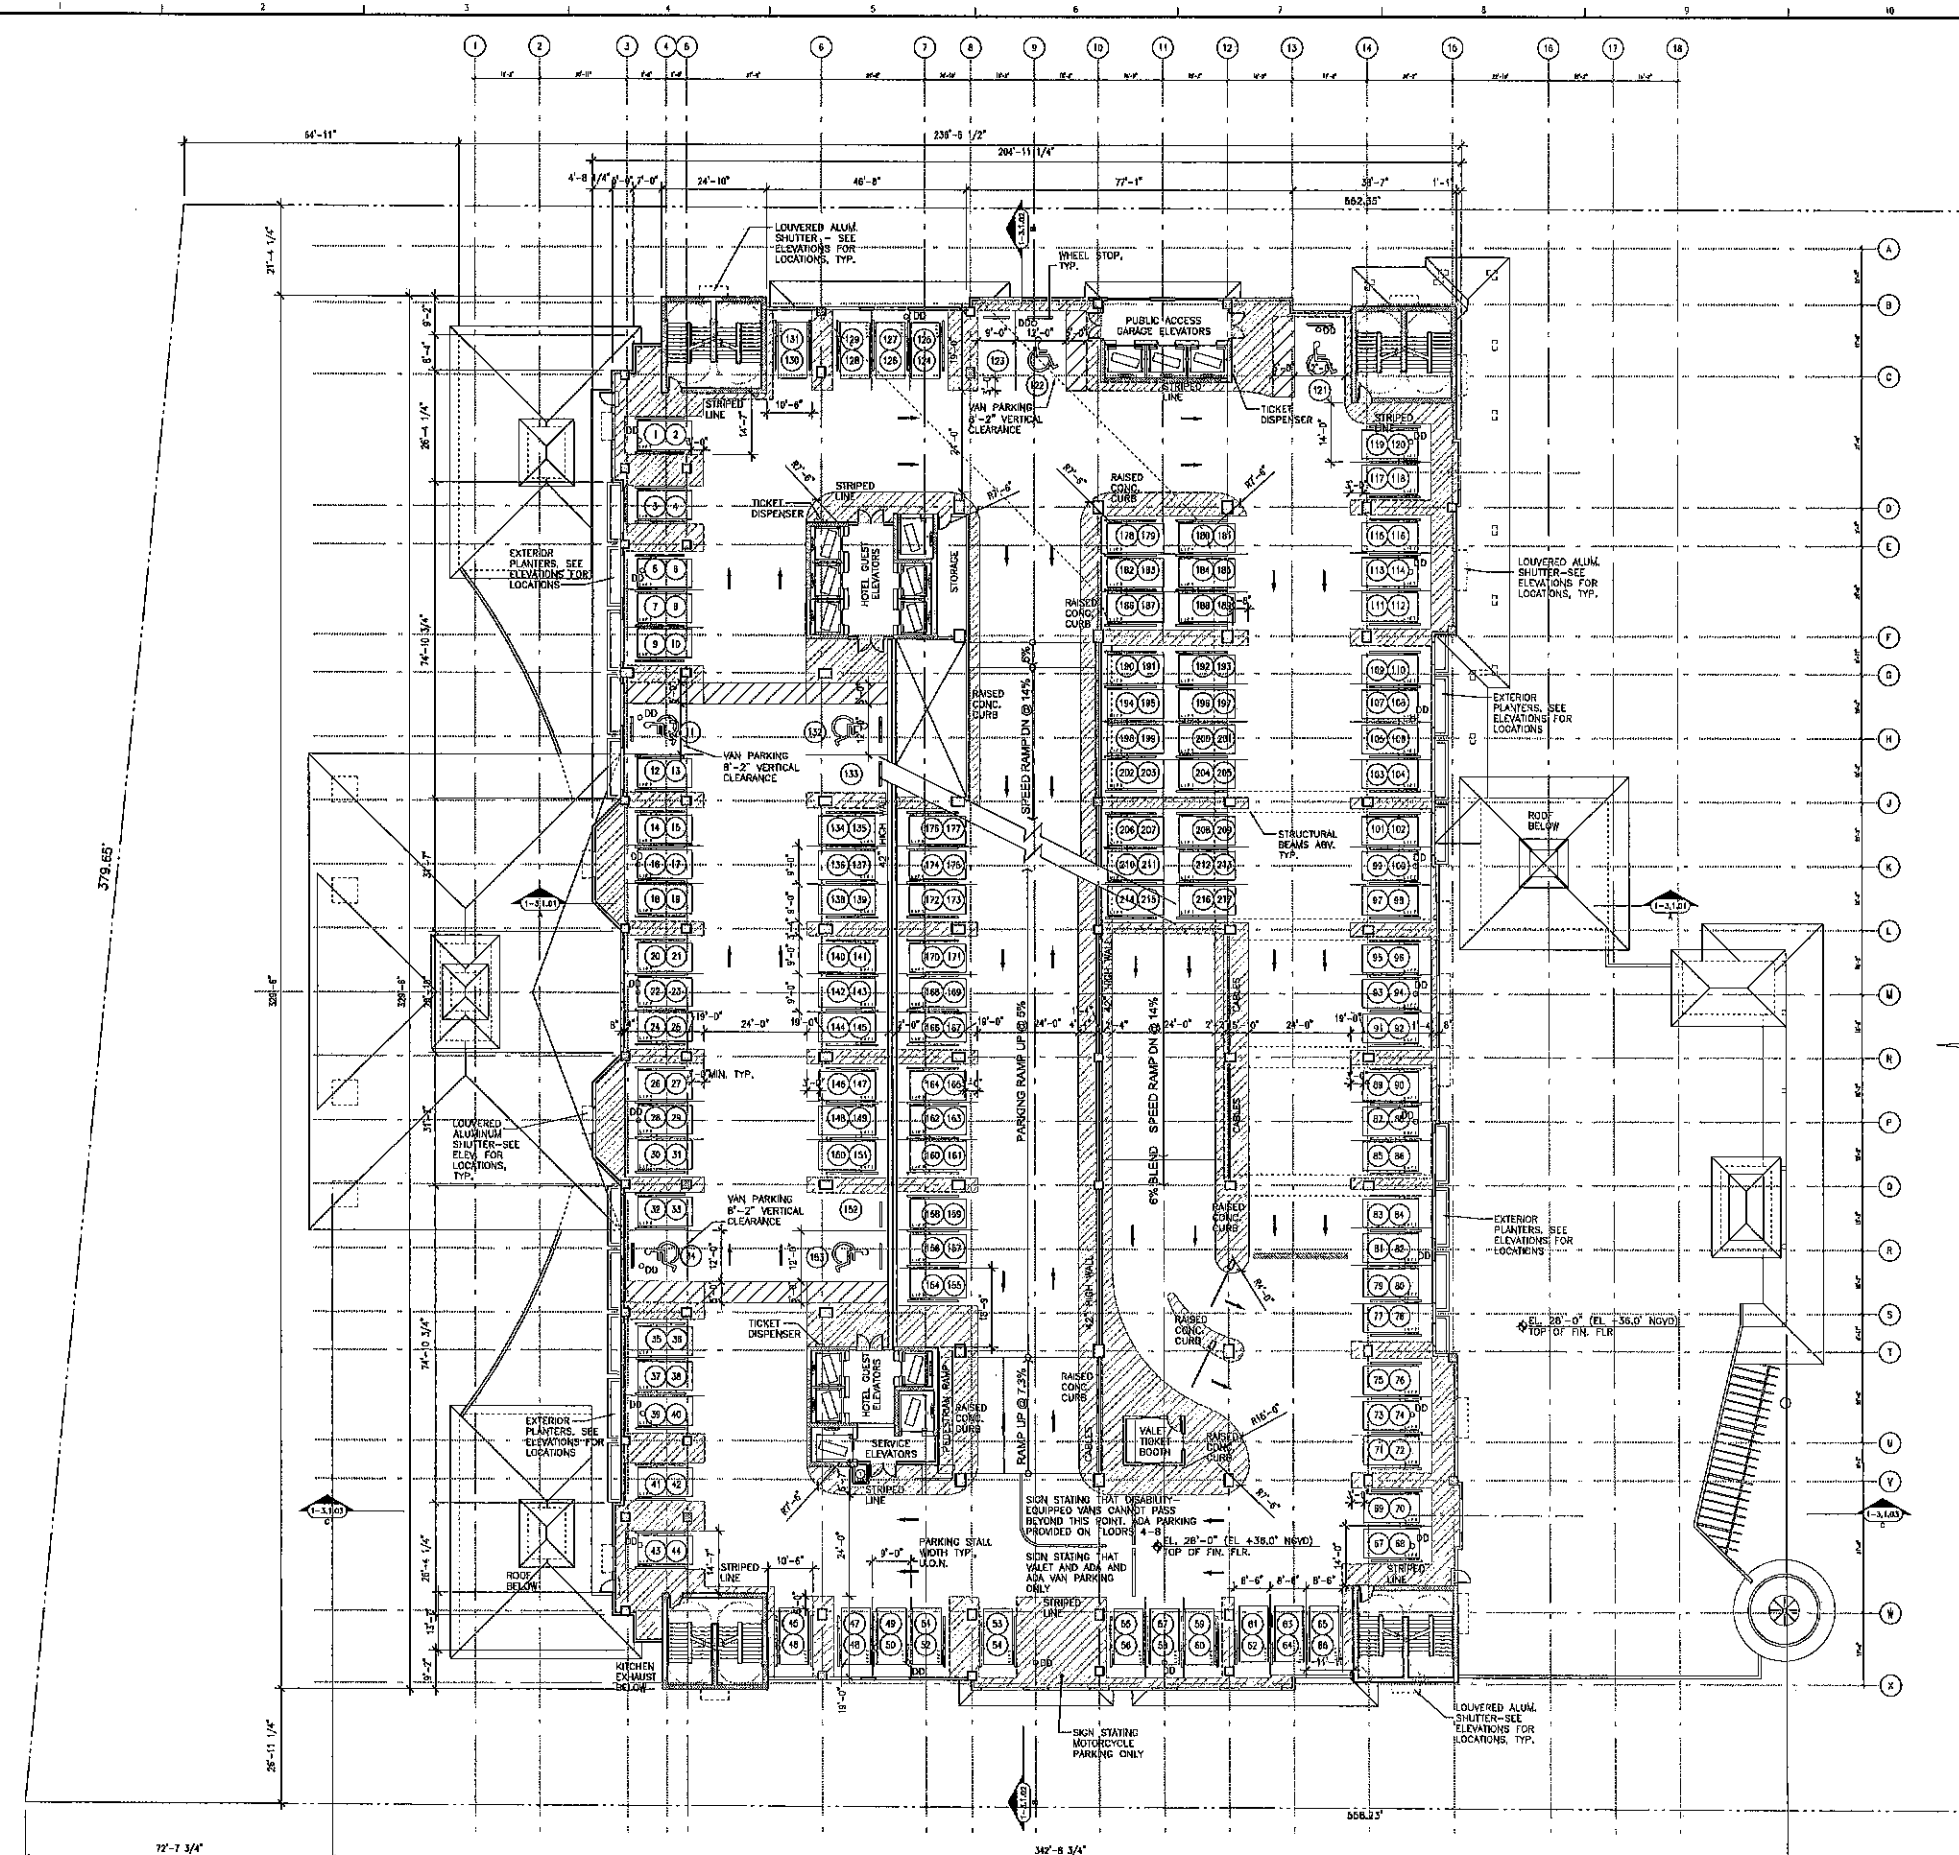

SUMMARY OF PARKING PROVIDED					
SHEET	FLOOR	ELEVATION	# SPACES	NOTES	TOTAL
A-1.3.03	3RD-VALET	28'-0"	35	8 (1208 CAR LIFTS)	217
A-1.3.04	4TH	40'-0"	37		148
A-1.3.05	5TH	52'-0"	37	14-4 CAR LIFTS	151
A-1.3.06	6TH	64'-0"	37		161
A-1.3.07	7TH	76'-0"	37		161
A-1.3.08	8TH	88'-0"	37		161
A-1.3.221	221TH	2644'-0"	37		161
A-1.3.222	222TH	2656'-0"	37		16



***NOTE: AUTOMOBILE MECHANICAL LIFTS ARE BEING USED. SEE PLAN FOR LOCATIONS. 2 SPACES FOR EVERY AUTO LIFT LOCATIONS ~ 217 TOTAL

***NOTE: HC = ACCESSIBLE PARKING SPACES REQUIRED FOR A PARKING LOT WITH A TOTAL OF 1001 SPACES AND OVER = 20 + 1 FOR EACH 100 OVER 1000 = 21 SPACES REQUIRED. 3 ARE VAN ACCESSIBLE. SUBMIT TO 11-4.1.2(6a-B) OF THE FLORIDA ADA ACCESSIBILITY CODE.

***NOTE: THERE ARE 5 ON GRADE PARKING SPACES AT INTRACASTAL SIDE PARKING LOT.

PUBLIC PARKING, HOTEL GUEST
AND EMPLOYEE PARKING

TOTAL PARKING SPACES
THIS FLOOR ≈ 151 X 3 TYP. FLRS. = 453

PROJECT DESIGN TEAM:
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CONSULTING ENGINEERING & SCIENCE, INC.
10000A WIDE ORBITE DR
MIAMI, FLORIDA 33155
(305) 276-6555 FAX: (305) 279-4405



300 JOHNSON STREET
HOLLYWOOD BEACH, FLORIDA

SEAL:

ISSUED FOR: TAC FINAL
DATE: 10/29/2010



[illegible]

SHEET TITLE:
TYPICAL 5TH THROUGH
7TH FLOOR PLAN

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DATE: _____
SCALE: 1/16"=1'-0"
DRAWN BY: EJ
CHECKED BY: JB
JOB NO.: 94.08A

SHEET NO.:
A-1.3.05

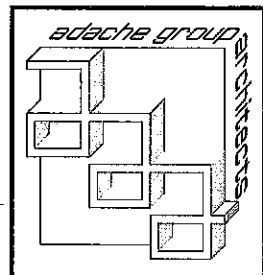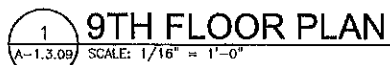

PROJECT DESIGN TEAM:
ARCHITECTS
ALANCO GROUP ARCHITECTS
400 SOUTH DELAWARE AVENUE, SUITE 100
LAURELHURST, FL, FLORIDA 33015
PH: (305) 426-6123 FAX: (305) 725-4169
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PH: (802) 486-2295 FAX: (802) 486-2295
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M.E.P. ENGINEER
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STRUCTURAL ENGINEER
TRISTAR CONSULTING ENGINEERING
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FORT LAUDERDALE, FLORIDA 33304
(561) 484-7777 FAX: (561) 484-7034

CIVIL ENGINEER
CONSULTING ENGINEERING & SCIENCE, INC.
1000 GLENDALE DRIVE, SUITE 400
MANASSAS, VIRGINIA 20108
(703) 394-5955 FAX (703) 294-0033

OWNER: MARGARITAVILLE HOLLYWOOD
BEACH RESORT, LLC.
3501 N. OCEAN DRIVE
HOLLYWOOD, FLORIDA 33019



SEAL:

ISSUED FOR: TAC FINAL
DATE: 10/29/2010

REVIEWS:		
No.	DATE	REMARKS
1	2000-01-01	
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SHEET TITLE:
9TH FLOOR PLAN

ALL IDEAS, DESIGNS, ARRANGEMENTS, PLANS AND SPECIFICATIONS INDICATED OR REPRESENTED BY THIS DRAWING ARE OWNED BY, AND THE PROPERTY OF ADACHE GROUP ARCHITECTS, INC. AND WERE CREATED, EVOLVED AND DEVELOPED FOR USE ON, AND IN CONNECTION WITH, THE SPECIFIED PROJECT. NONE OF THE IDEAS, PLANS, ARRANGEMENTS, AND SPECIFICATIONS SHALL BE USED BY OR DISCLOSED TO ANY PERSON, CORPORATION OR FIRM FOR ANY PURPOSE WHATSOEVER WITHOUT THE WRITTEN PERMISSION OF ADACHE GROUP ARCHITECTS. VISUAL CONTACT WITH THESE PLANS OR SPECIFICATIONS SHALL CONSTITUTE CONCLUSIVE EVIDENCE OF ACCEPTANCE OF THESE RESTRICTIONS. ALL RIGHTS RESERVED. © 2010

FLORIDA LICENSE # AR0007073

DATE: _____
SCALE: 1/16"=1'-0"
DRAWN BY: JB
CHECKED BY: JB
JOB NO.: 94.06A

SHEET NO.: A-1.3.09

OWNER: MARGARITAVILLE HOLLYWOOD
BEACH RESORT, LLC.
3501 N. OCEAN DRIVE
HOLLYWOOD, FLORIDA 33018



SEAL:

ISSUED FOR: TAC FINAL

DATE: 10/29/2010

[illegible]


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10TH FLOOR PLAN


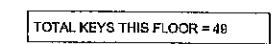
ALL IDEAS, DESIGNS, ARRANGEMENTS, PLANS AND SPECIFICATIONS INDICATED OR OTHERWISE REPRESENTED BY THIS DRAWING ARE OWNED BY, AND THE PROPERTY OF, ADACHI GROUP ARCHITECTS, INC., AND WERE CREATED, EVOLVED AND DEVELOPED FOR USE ON, AND IN CONNECTION WITH, THE SPECIFIED PROJECT. NONE OF THESE IDEAS, PLANS, ARRANGEMENTS, AND SPECIFICATIONS SHALL BE USED BY OR DISCLOSED TO ANY PERSON, CORPORATION OR FIRM FOR ANY PURPOSE WHATSOEVER WITHOUT THE WRITTEN PERMISSION OF ADACHI GROUP ARCHITECTS. VISUAL CONTACT WITH THESE PLANS OR SPECIFICATIONS SHALL CONSTITUTE CONCLUSIVE EVIDENCE OF ACCEPTANCE OF THESE RESTRICTIONS. ALL RIGHTS RESERVED. © 2010

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DATE: _____
SCALE: 1/16"=1'-0"
DRAWN BY: JB
CHECKED BY: JB
JOB NO.: 94.06A

SHEET NO.:
A-1.3.10

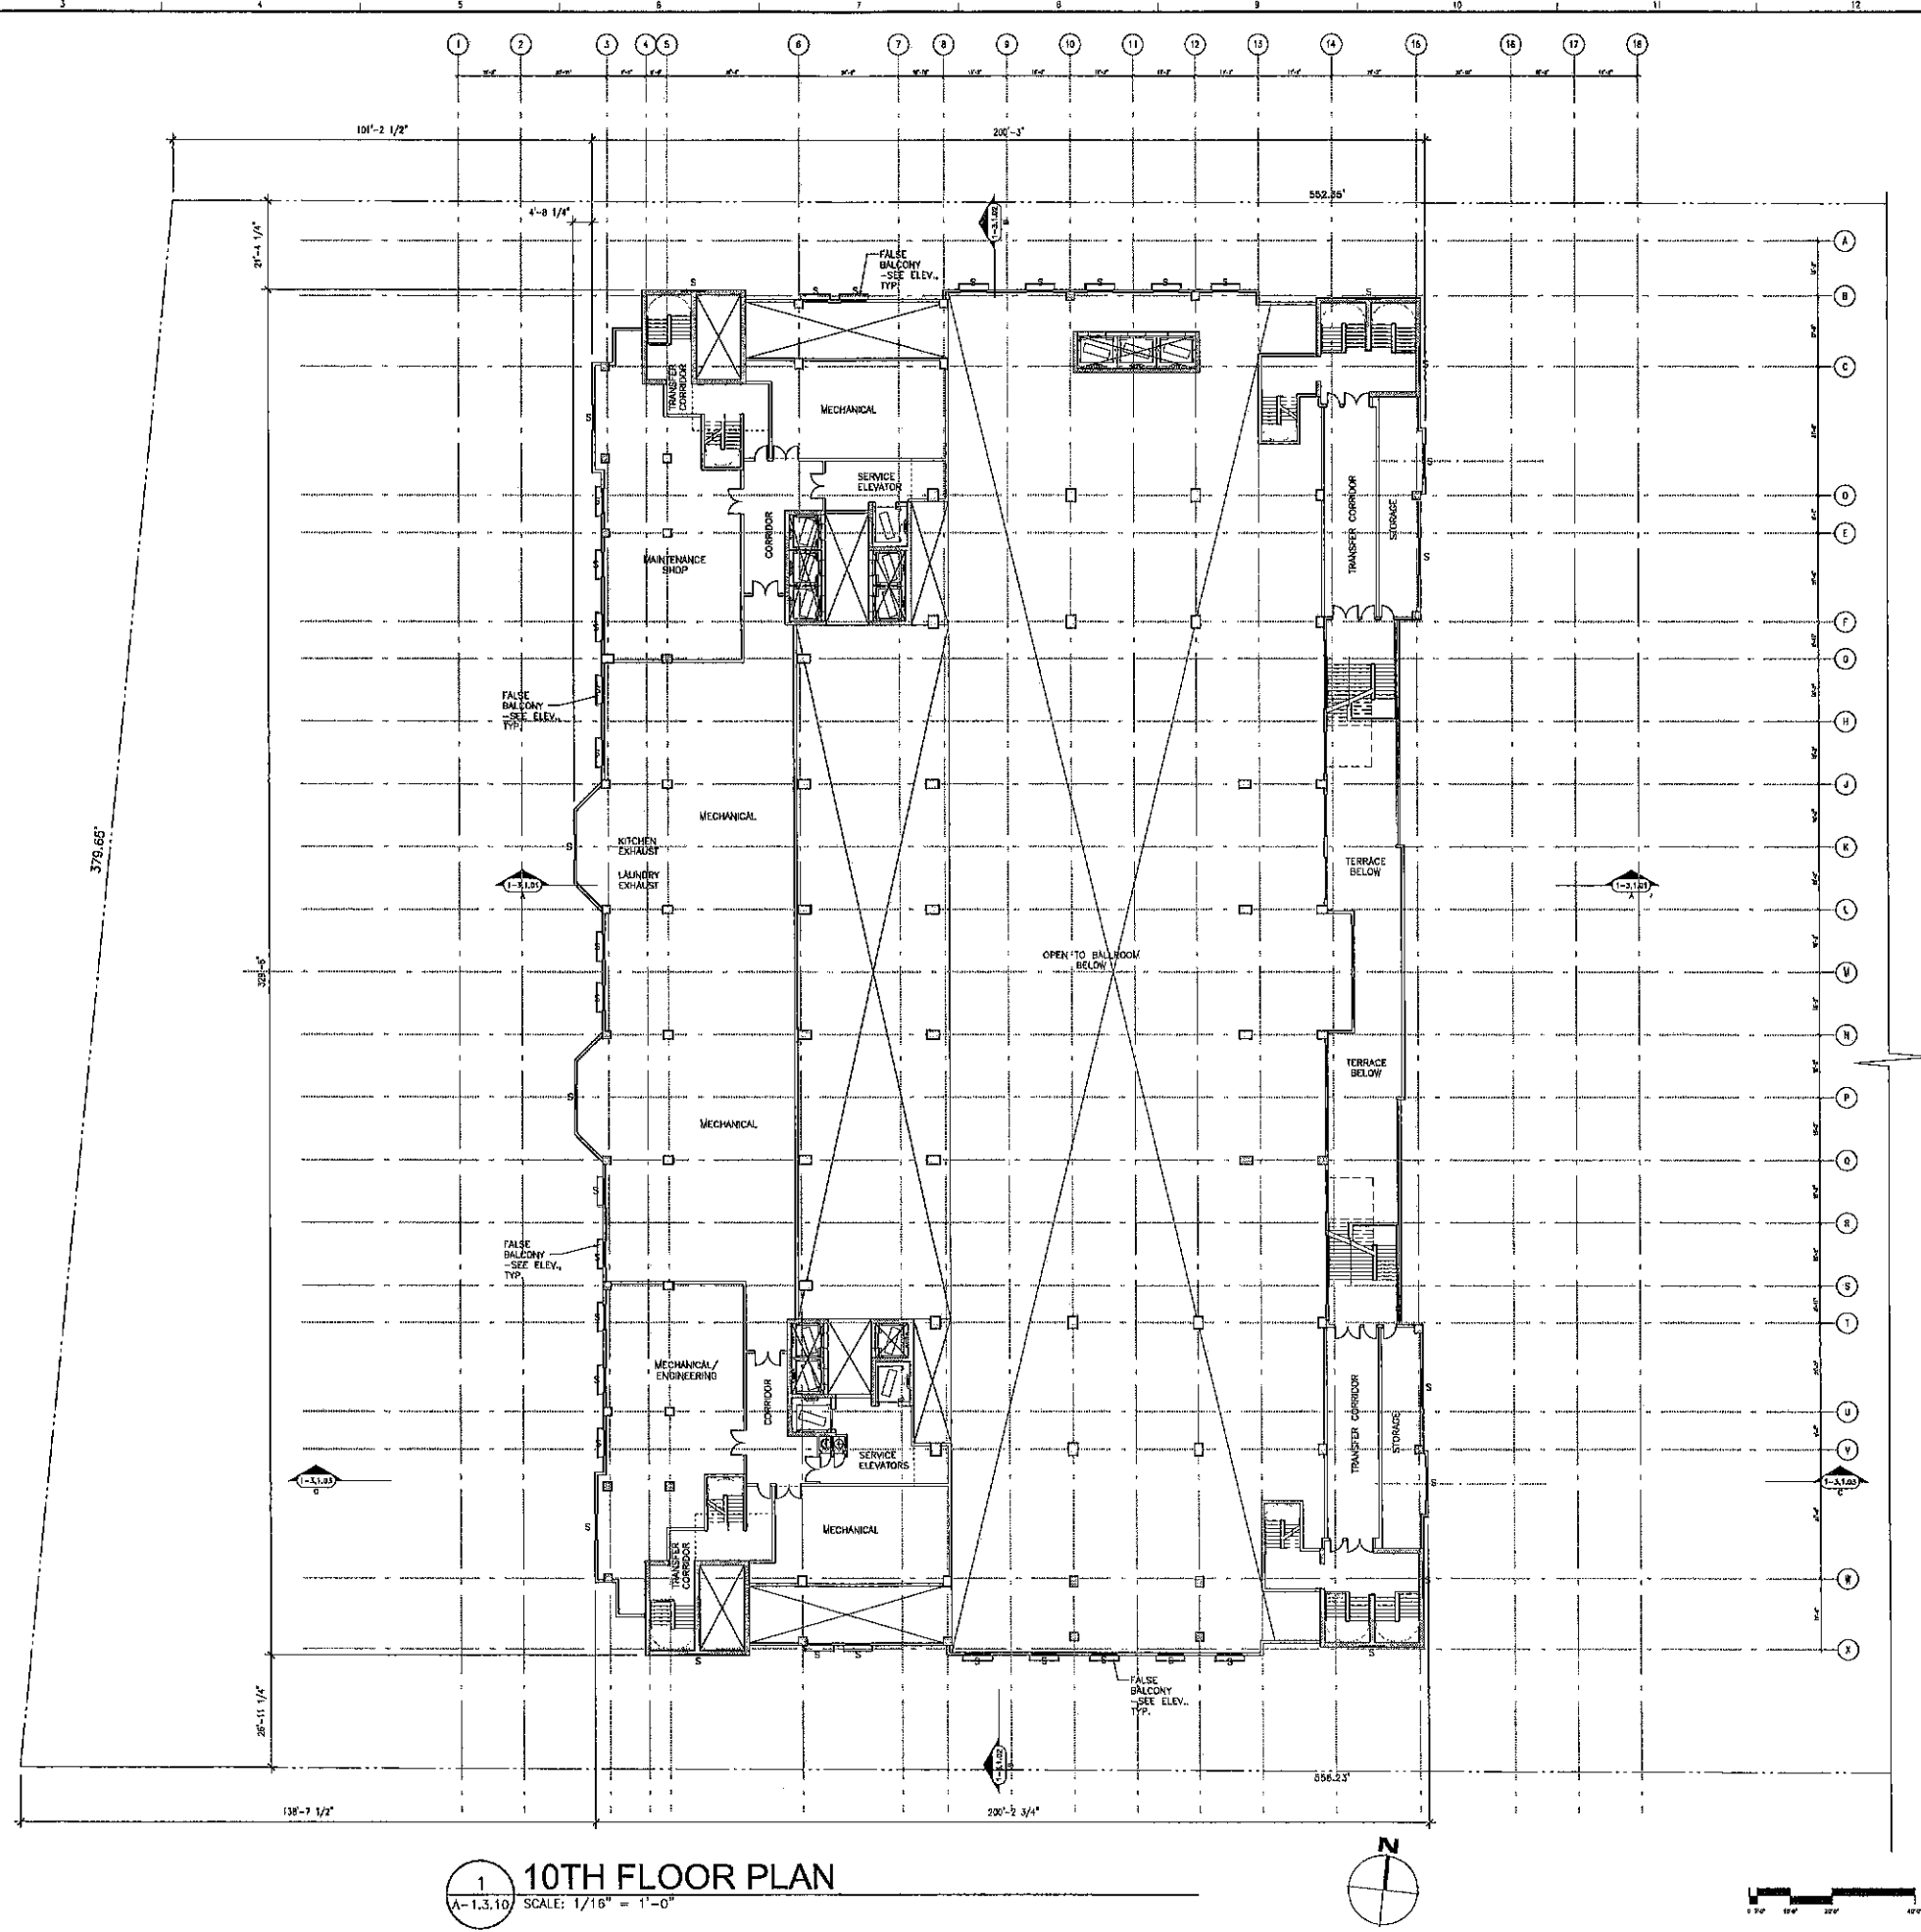

The logo for adache group architects features the company name in a stylized, lowercase font. The word "adache" is in a bold, sans-serif typeface, while "group" is in a smaller, lighter font. Below "adache" is the word "architects" in a tall, narrow, sans-serif font. The entire logo is enclosed within a square frame that has a 3D, isometric appearance, with lines suggesting depth and perspective.

OWNER: MARGARITAVILLE HOLLYWOOD
BEACH RESORT, LLC.
3501 N. OCEAN DRIVE
HOLLYWOOD, FLORIDA 33019



SEAL:

ISSUED FOR: TAC FINAL
DATE: 10/29/2010

[illegible]


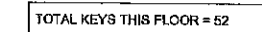
SHEET TITLE:
ELEVENTH FLOOR PLAN

ALL IDEAS, DESIGNS, ARRANGEMENTS, PLANS AND SPECIFICATIONS INDICATED OR REPRESENTED BY THIS DRAWING ARE OWNED BY, AND THE PROPERTY OF ADACHE GROUP ARCHITECTS, INC. AND WERE CREATED, EVOLVED AND DEVELOPED FOR USE ON, AND IN CONNECTION WITH, THE SPECIFIED PROJECT. NONE OF THESE IDEAS, PLANS, ARRANGEMENTS AND SPECIFICATIONS SHALL BE USED BY OR DISCLOSED TO ANY PERSON, CORPORATION OR FIRM FOR ANY PURPOSE WHATSOEVER WITHOUT THE WRITTEN PERMISSION OF ADACHE GROUP ARCHITECTS. VISUAL CONTACT WITH THESE PLANS OR SPECIFICATIONS SHALL CONSTITUTE CONCLUSIVE EVIDENCE OF ACCEPTANCE OF THESE RESTRICTIONS. ALL RIGHTS RESERVED. © 2010

FLORIDA LICENSE # A00007073


DATE: _____
SCALE: 1/16"=1'-0"
DRAWN BY: EJ
CHECKED BY: JB
JOB NO.: 94.08A

SHEET NO.: _____
A-1.3.11



adache group
architects

SHEET NO.:
A-1.3.12

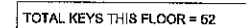

PROJECT DESIGN TEAM:
ARCHITECTS
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CIVIL ENGINEER
CONSULTING ENGINEERING & SCIENCE, INC.
10100 NEADDALE DRIVE, SUITE 400
MIAMI, FLORIDA 33156
(305) 276-5055 FAX: (305) 278-4503

OWNER: MARGARITAVILLE HOLLYWOOD
BEACH RESORT, LLC.
3501 N. OCEAN DRIVE
HOLLYWOOD, FLORIDA 33019



SEAL:

ISSUED FOR: TAC FINAL
DATE: 10/29/2010

[illegible]


SHEET TITLE:
17TH FLOOR PLAN

ALL IDEAS, DESIGNS, ARRANGEMENTS, PLANS AND SPECIFICATIONS INDICATED OR REPRESENTED BY THIS DRAWING ARE OWNED BY, AND THE PROPERTY OF ADACHE GROUP ARCHITECTS, INC. AND WERE DEVELOPED, EVOLVED AND DEVELOPED FOR USE ON, AND IN CONNECTION WITH THE SPECIFIED PROJECT. NONE OF THESE IDEAS, PLANS, ARRANGEMENTS, AND SPECIFICATIONS SHALL BE USED BY OR DISCLOSED TO ANY PERSON, CORPORATION OR FIRM FOR ANY PURPOSE WHATSOEVER WITHOUT THE WRITTEN PERMISSION OF ADACHE GROUP ARCHITECTS. VISUAL CONTACT WITH THESE PLANS OR SPECIFICATIONS SHALL CONSTITUTE CONCLUSIVE EVIDENCE OF ACCEPTANCE OF THESE RESTRICTIONS. ALL RIGHTS RESERVED. ©2010


FLORIDA LICENSE # AR0007073

DATE: _____
SCALE: 1/16"=1'-0"
DRAWN BY: EJ
CHECKED BY: JD
JOB NO.: 94.08A

SHEET NO.: A-1.3.17

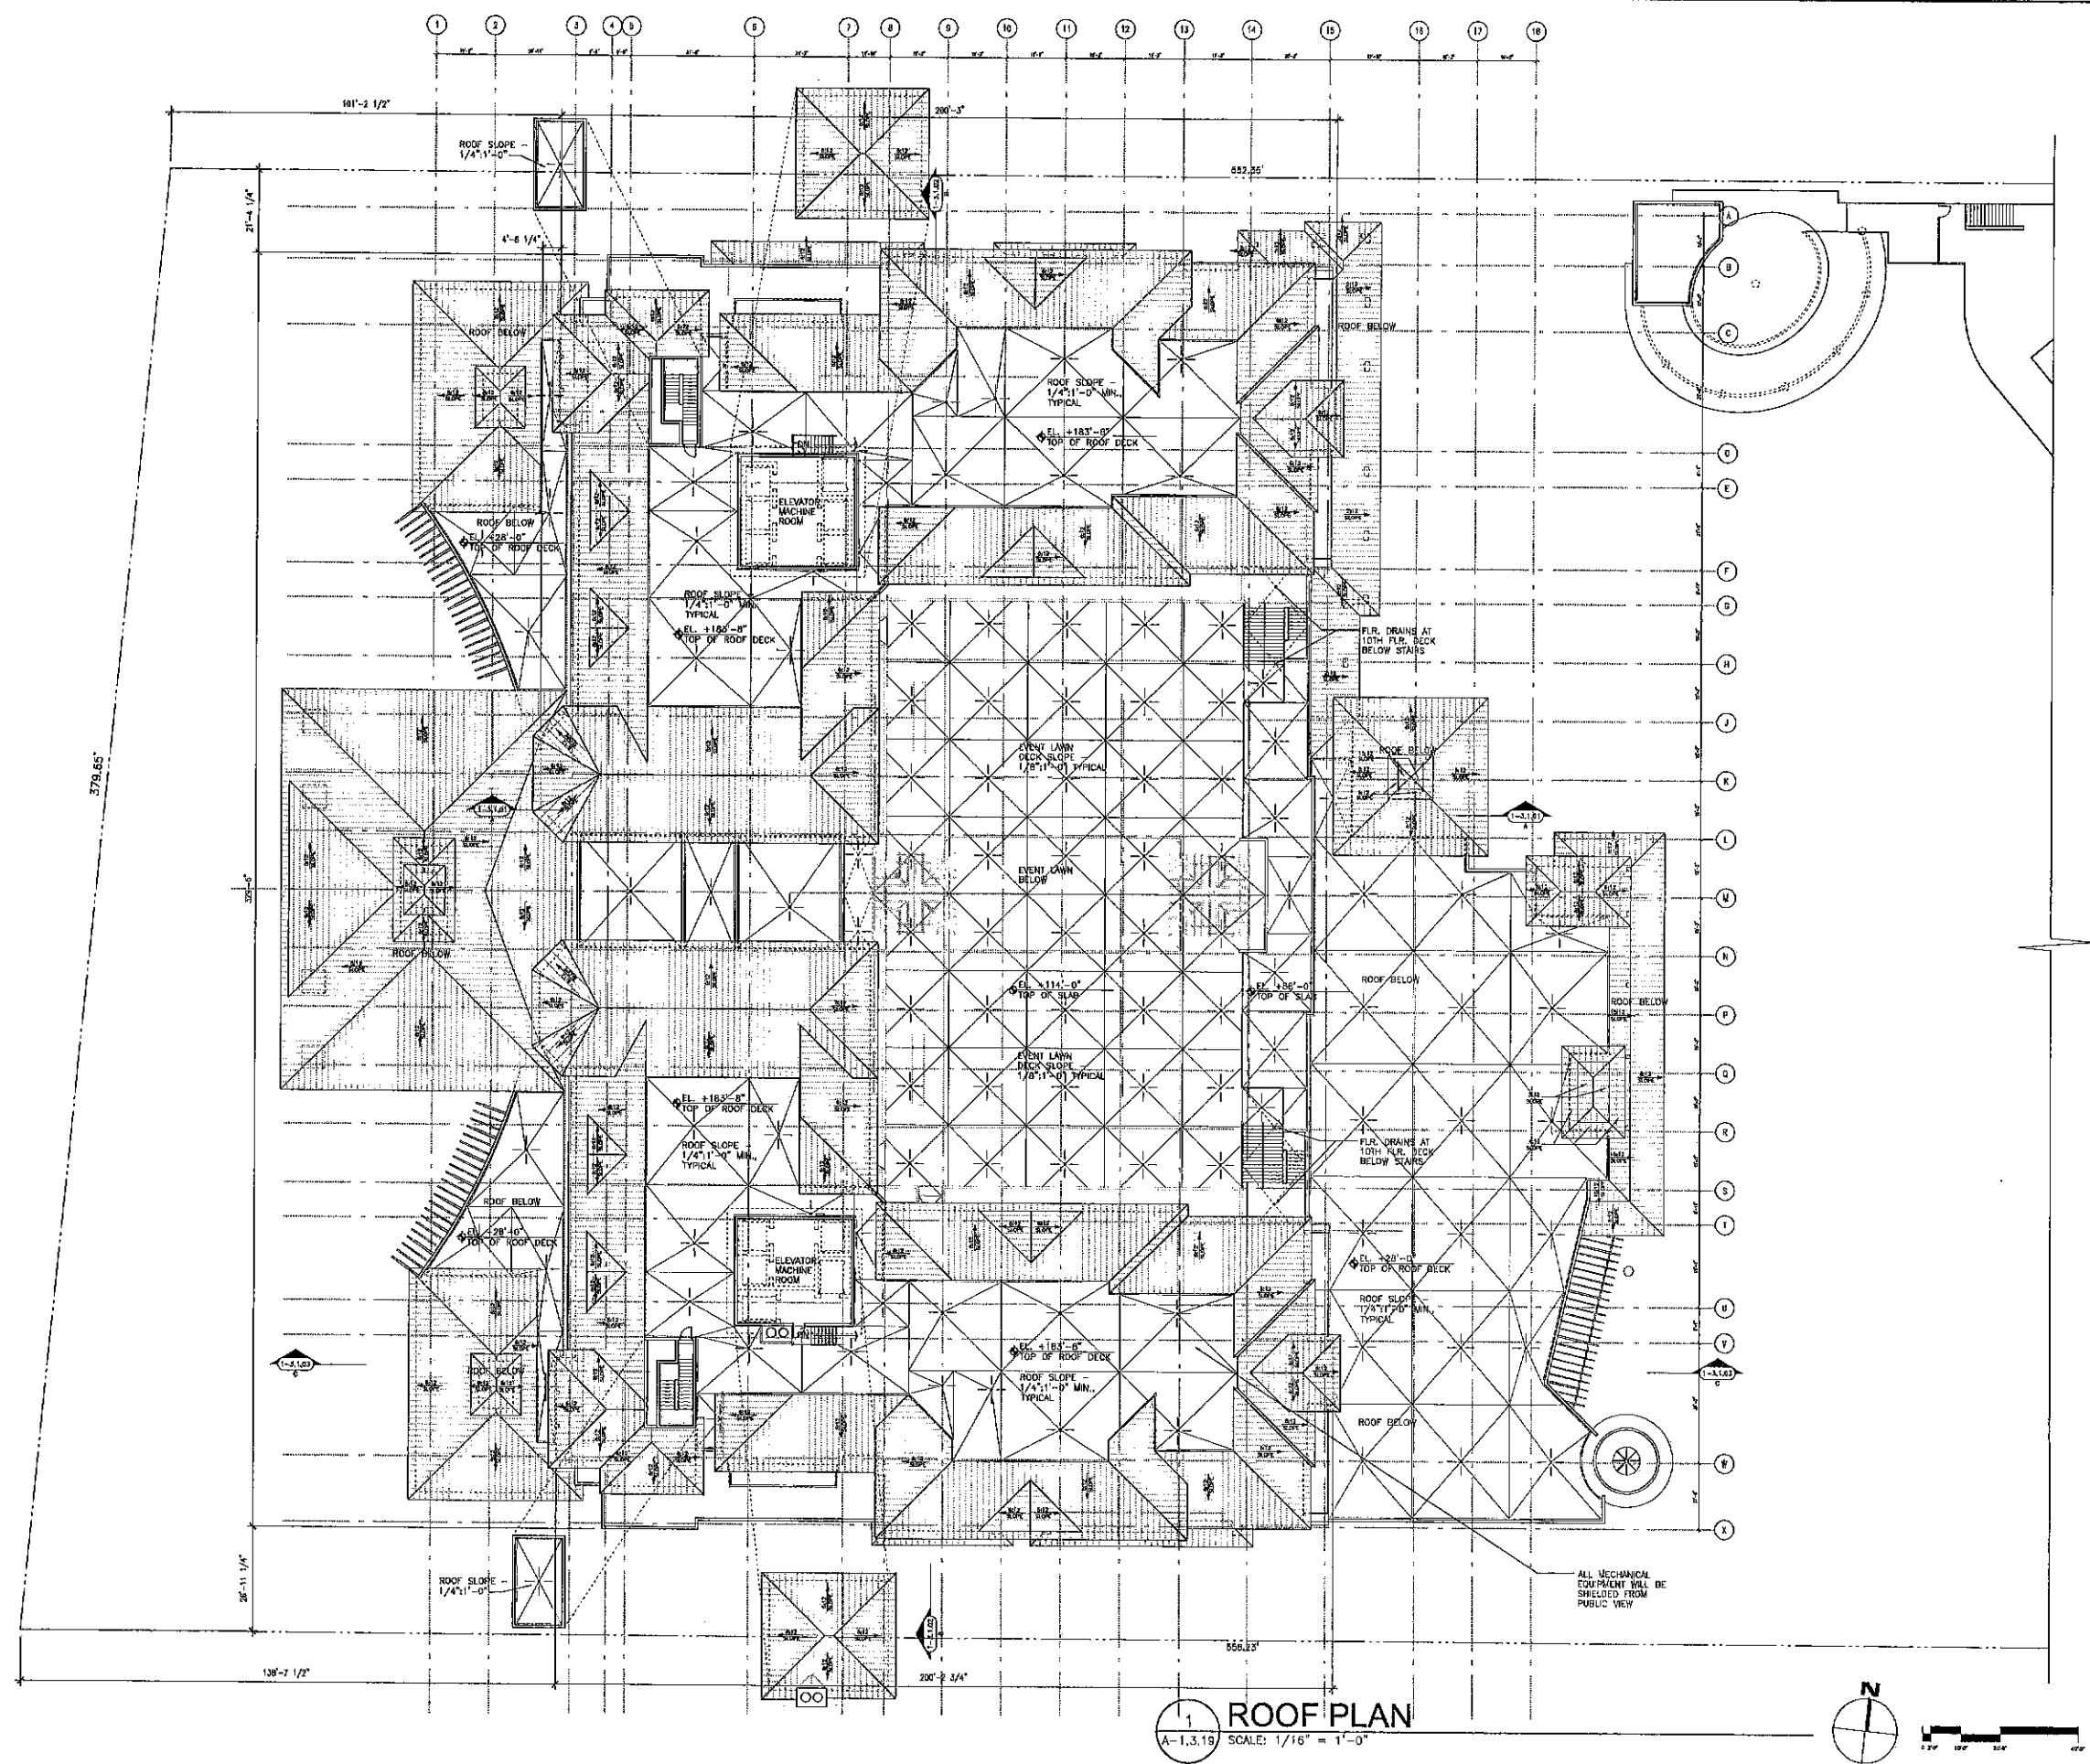

1
A-1.3.19 ROOF PLAN
SCALE: 1/16" = 1'-0"

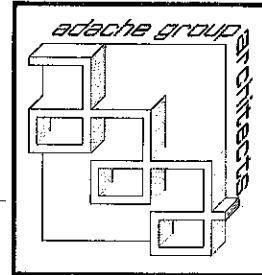

PROJECT DESIGN TEAM:
ARCHITECTS
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CIVIL ENGINEER
CONSULTING ENGINEERING & SCIENCE, INC.
10700 REEDS BLVD. SUITE 400
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(305) 378-8338 FAX: (305) 378-4333

OWNER: MARGARITAVILLE HOLLYWOOD
BEACH RESORT, LLC.
3801 N. OCEAN DRIVE
HOLLYWOOD, FLORIDA 33019



SEAL:

ISSUED FOR: TAC FINAL
DATE: 10/29/2010



REVISIONS:		
No.	DATE	REMARKS

SHEET TITLE:
ROOF PLAN

ALL IDEAS, DESIGNS, ARRANGEMENTS, PLANS AND SPECIFICATIONS INDICATED OR REPRESENTED BY THIS DRAWING ARE OWNED BY, AND THE PROPERTY OF, ADACHE GROUP ARCHITECTS, INC. AND WERE CREATED, EVOLVED AND DEVELOPED FOR USE ON, AND IN CONNECTION WITH, THE SPECIFIC PROJECT. NONE OF THESE IDEAS, PLANS, ARRANGEMENTS AND SPECIFICATIONS SHALL BE USED BY OR DISCLOSED TO ANY PERSON, CORPORATION OR FIRM FOR ANY PURPOSE WHATSOEVER WITHOUT THE WRITTEN PERMISSION OF ADACHE GROUP ARCHITECTS. VIOLATION OF THESE PLANS OR SPECIFICATIONS SHALL CONSTITUTE CONCLUSIVE EVIDENCE OF ACCEPTANCE OF THESE RESTRICTIONS. ALL RIGHTS RESERVED, © 2010
FLORIDA LICENSE # AR0002073

DATE: 10/29/2010
SCALE: 1/16" = 1'-0"
DRAWN BY: JR
CHECKED BY: JB
JOB NO.: 94.08A

SHEET NO.:
A-1.3.19

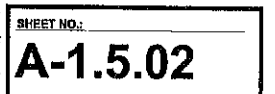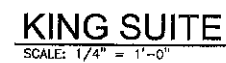

OWNER: MARGARITAVILLE HOLLYWOOD
BEACH RESORT, LLC.
3501 N. OCEAN DRIVE
HOLLYWOOD, FLORIDA 33019



SEAL:

ISSUED FOR: TAC FINAL
DATE: 10/29/2010


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SHEET TITLE:
ENLARGED VICE-
PRESIDENTIAL SUITE PLAN

ALL IDEAS, DESIGNS, ARRANGEMENTS, PLANS AND SPECIFICATIONS INDICATED OR REPRESENTED BY THIS DRAWING ARE OWNED BY, AND THE PROPERTY OF ADACHE GROUP ARCHITECTS, INC. AND WERE CREATED, EVOLVED AND DEVELOPED FOR USE ON, AND IN CONNECTION WITH, THE SPECIFIED PROJECT. NONE OF THESE IDEAS, PLANS, ARRANGEMENTS, AND SPECIFICATIONS SHALL BE USED BY OR DISCLOSED TO ANY PERSON, CORPORATION OR FIRM FOR ANY PURPOSE WHATSOEVER WITHOUT THE WRITTEN PERMISSION OF ADACHE GROUP ARCHITECTS. IN CONTACT WITH THESE PLANS OR SPECIFICATIONS SHALL CONSTITUTE CONCLUSIVE EVIDENCE OF ACCEPTANCE OF THESE RESTRICTIONS. ALL RIGHTS RESERVED. © 2010
FLORIDA LICENSE # AR0007073

DATE: _____
SCALE: 1/4"=1'-0"
DRAWN BY: SW
CHECKED BY: JB
JOB NO.: 04.00A

SHEET NO.: _____
A-1.5.04

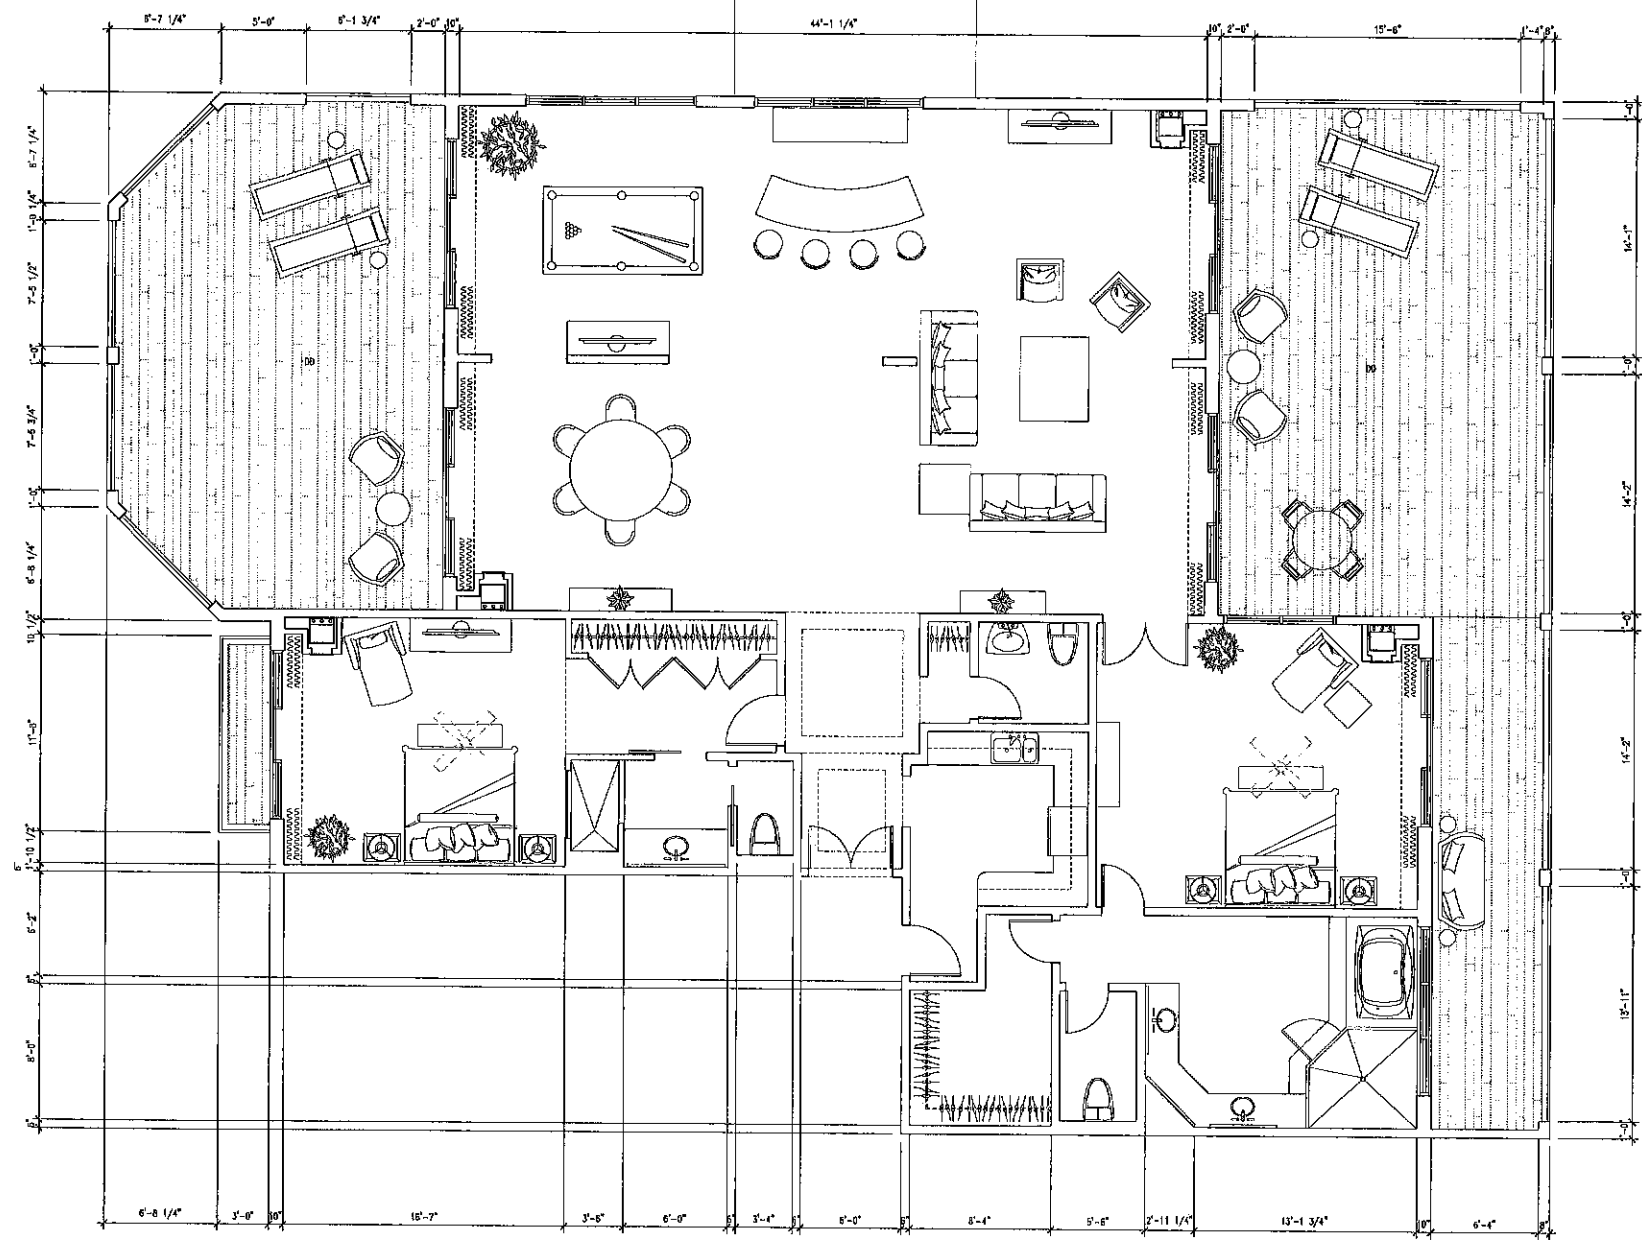

VICE PRESIDENTIAL SUITE
SCALE: 1/4" = 1'-0"

OWNER: MARGARITAVILLE HOLLYWOOD
BEACH RESORT, LLC.
3501 N. OCEAN DRIVE
HOLLYWOOD, FLORIDA 33019



SEAL:

ISSUED FOR: TAC FINAL
DATE: 10/29/2010

REVISIONS:

[illegible]

SHEET TITLE:
EXTERIOR ELEVATION

ALL IDEAS, DESIGNS, ARRANGEMENTS, PLANS AND SPECIFICATIONS INDICATED OR REPRESENTED BY THIS DRAWING ARE OWNED BY, AND THE PROPERTY OF ADACHE GROUP ARCHITECTS, INC. AND WERE CREATED, EVOLVED AND DEVELOPED FOR USE ON, AND IN CONNECTION WITH, THE SPECIFIED PROJECT. NONE OF THESE IDEAS, PLANS, ARRANGEMENTS, AND SPECIFICATIONS SHALL BE USED BY OR DISCLOSED TO ANY PERSON, CORPORATION OR FIRM FOR ANY PURPOSE WHATSOEVER WITHOUT THE WRITTEN PERMISSION OF ADACHE GROUP ARCHITECTS. VISUAL CONTACT WITH THESE PLANS OR SPECIFICATIONS SHALL CONSTITUTE CONCLUSIVE EVIDENCE OF ACCEPTANCE OF THESE RESTRICTIONS. ALL RIGHTS RESERVED. ©2010

FLORIDA LICENSE # AR0007073

DATE: _____
SCALE: 1/16"=1'-0"
DRAWN BY: JR
CHECKED BY: JB
JOB NO.: 94.08A

SHEET NO.:
A-2.1.01




1 WEST EXTERIOR ELEVATION
A-2, 1.01 1/16"=1'-0"

GENERAL NOTES

- 3) CHAPTER 166.062 OF THE FLORIDA STATUTES DEFINES UNIFORM GLASS (REGARDING TURTLE CLOUTS) AS GLASS TREATED TO ACHIEVE AN INDUSTRY APPROVED, INSIDE TO OUTSIDE LIGHT TRANSMITTANCE VALUE OF 45% OR LESS, THIS IS NOT THE SAME AS THE GLASS'S SHADING COEFFICIENT - FOR EXAMPLE, PPG'S SOLARGUARD HAS A LIGHT TRANSMITTANCE OF 44%, HOWEVER ITS SHADING COEFFICIENT IS 0.88.
- 4) ANY EXTERIOR METAL FRAMING FOR ANY PART OF THE BUILDING ENVELOPE SHALL MEET LARGE MISSILE IMPACT LOWER THAN 30" HIGH AND SMALL MISSILE IMPACT GREATER THAN 30" HIGH.
- 5) IMPROVE LARGE IMPACT WINDOWS WHERE THERE IS A DROP OF MORE THAN 4'-0" ON THE FAR SIDE OF SUCH WINDOWS AND THE BUILDING IS WITHIN THE NEAR RISK NEARBY WALKING SURVIVANCE TO ACT AS A SAFEGUARD TO PREVENT THE FALL OF PERSONS WHEN SUCH WINDOWS ARE OPEN.
- 6) ALL OPERABLE WINDOWS TO HAVE SLATS MINIMUM 36" A.F.F.
- 7) SLAT BALCONIES TO HAVE (SAFEGUARDS) RAILINGS 42" HIGH A.F.F.
- 8) 5' ON ELEVATION INDICATED SPANDREL GLASS.

ELEVATION KEY NOTES:

- | | | | |
|--|--|---|-------------------------------------|
| 1 STANDING SEAM METAL ROOF, SEE A-2.1.05 FOR COLOR. | 10 TOOLED SMOOTH STUCCO LAP SIDING, COLOR/WHITE, SEE COLOR SWATCH. | 19 TADY COQUINA SHELL STUCCO, COLOR, SEE COLOR SWATCH. | 28 WHITE ALUMINUM FASCIA. |
| 2 WHITE ARCHITECTURAL FOAM MOLDING & BRACKETS TYP. SEE COLOR SWATCH. | 11 WHITE ARCHITECTURAL FOAM MOLDING. | 20 FALSE BALCONY FRENCH RAILING. | 29 GRADIENT PAINT COLOR APPLICATION |
| 3 ALUMINUM BAHAMA SHUTTERS TYPICAL, COLOR, FOUNTAIN BLUES, SEE COLOR SWATCH. | 12 WHITE ALUMINUM BRACKET. | 21 STORAGE: 23'-0" W X 16'-0" H (216 SF). | |
| 4 WHITE ALUMINUM & GLASS EXTERIOR IMPACT DOORS AND STOREFRONT. | 13 WHITE ALUMINUM DECORATIVE BRACKETS TYPICAL. | 22 FOUNTAIN WATER FEATURE. | |
| 5 WHITE ALUMINUM & GLASS IMPACT FIXED WINDOWS. | 14 WHITE ALUMINUM DECORATIVE OPEN LATTICE. | 23 FLAG POLES. | |
| 6 GLASS RAILING WITH WHITE ALUMINUM POSTS AND RAILING. | 15 OPEN TO GARAGE WITH WHITE ALUMINUM WINDOW FRAME (NO GLASS). | 24 WHITE ALUMINUM FIXED SHUTTERS. | |
| 7 WHITE ALUMINUM PICKET RAILINGS TYPICAL. | 16 SPANDREL GLASS. | 25 WHITE ALUMINUM AND GLASS EXTERIOR FIXED GLAZING. | |
| 8 SMOOTH STUCCO EXTERIOR FINISH, COLOR, WHITE, SEE COLOR SWATCH. | 17 EXTERIOR CONCRETE PLANTER, FINISH WHITE SMOOTH STUCCO. | 26 WHITE ALUMINUM DECORATIVE OPEN LATTICE, OPEN TO GARAGE BEYOND. | |
| 9 WHITE ALUMINUM TRELLIS. | 18 WHITE ALUMINUM VERTICAL TRELLIS FOR SPANDREL. | 27 WHITE DECORATIVE COLUMNS TYPICAL. | |

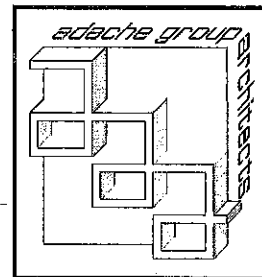

PROJECT DESIGN TEAM:
ARCHITECTS
ADACHE GROUP ARCHITECTS
600 SOUTH FEDERAL HIGHWAY PT.
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HANDWICKER CENTER, VT. 05768
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E-MAIL: twoen@twoen.com
CIVIL ENGINEER
CONSULTING ENGINEERING & SCIENCE, INC.
1070 BENDALL DRIVE, SUITE 400
MIAMI, FLORIDA 33175
(305) 378-5858 FAX: (305) 378-0333

OWNER: MARGARITAVILLE HOLLYWOOD
BEACH RESORT, LLC.
3501 N. OCEAN DRIVE
HOLLYWOOD, FLORIDA 33019



SEAL:

ISSUED FOR: TAC FINAL
DATE: 10/29/2010



REVISIONS:		
No.	DATE	REMARKS

SHEET TITLE:
STREET PROFILE


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FLORIDA LICENSE # AR0020703

DATE:
SCALE: 1/32"=1'-0"
DRAWN BY: JR
CHECKED BY: JB
JOB NO.: 94.08A

SHEET NO.:
A-2.1.01A

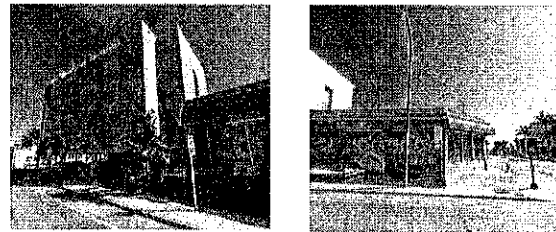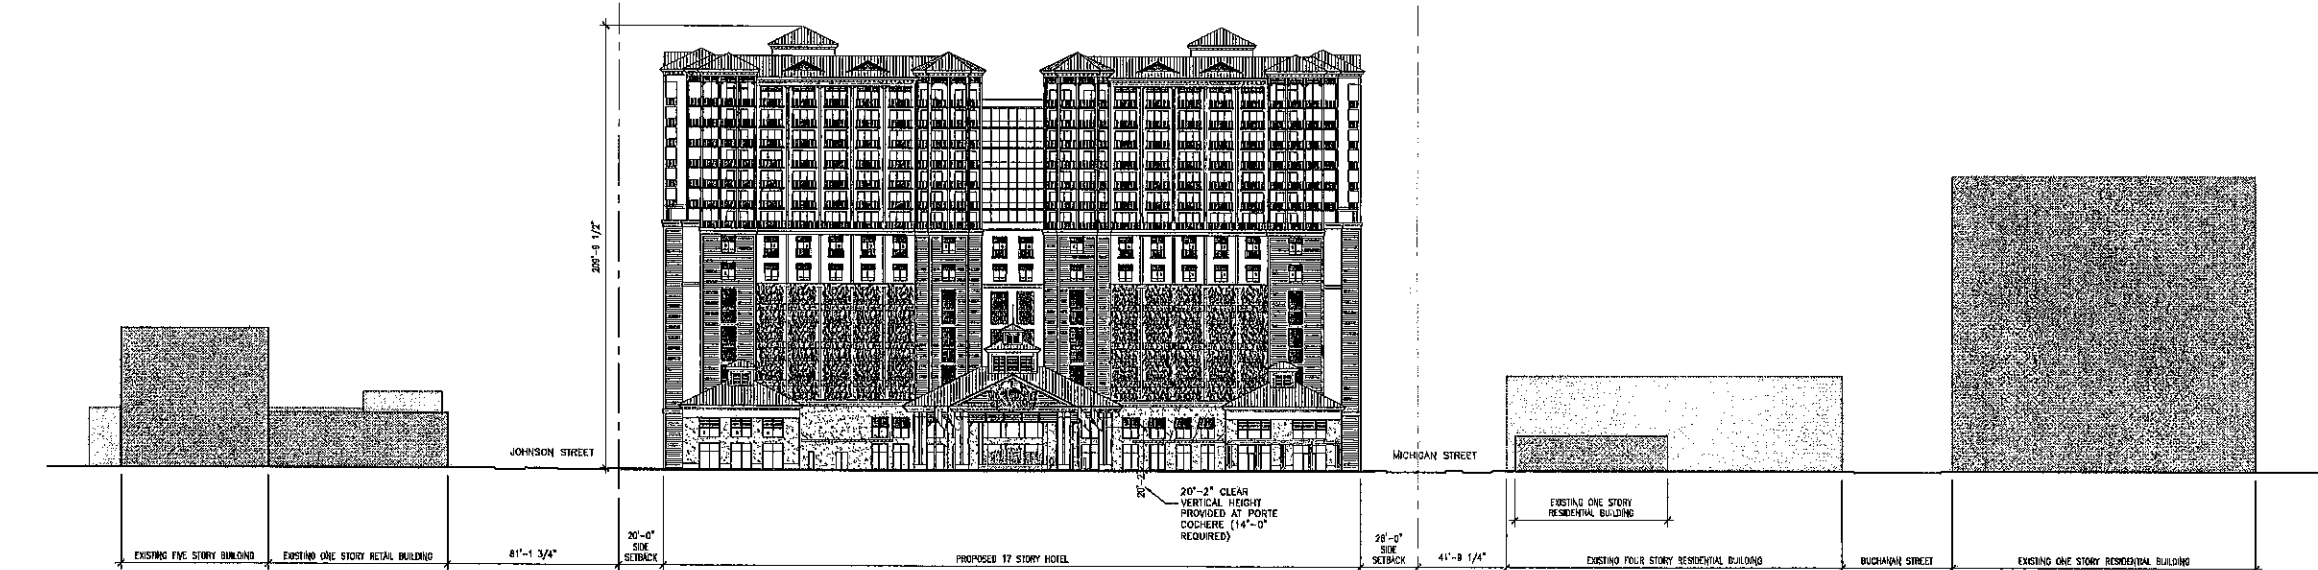


A1A/NORTH OCEAN BLVD. LOOKING NORTH

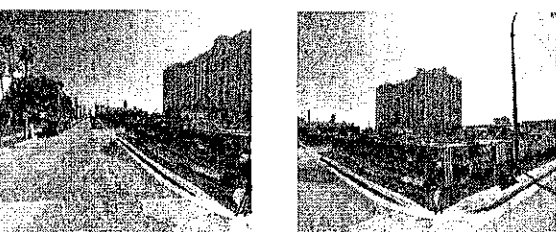

A1A/NORTH OCEAN BLVD. LOOKING SOUTH

1 WEST STREET PROFILE ELEVATION
A-2.1.01A 1/32"=1'-0"

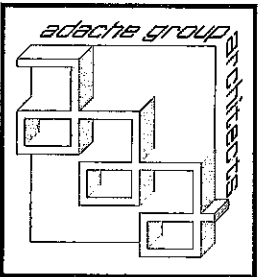

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OWNER: MARGARITAVILLE HOLLYWOOD
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3501 N. OCEAN DRIVE
HOLLYWOOD, FLORIDA 33019



SEAL:

ISSUED FOR: TAC FINAL
DATE: 10/29/2010


REVISIONS:		
No.	DATE	REMARKS

SHEET TITLE:
EXTERIOR ELEVATION

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DATE: 10/29/2010
SCALE: 1/16"=1'-0"
DRAWN BY: JR
CHECKED BY: JB
JOB NO.: 94.68A

SHEET NO.:
A-2.1.02

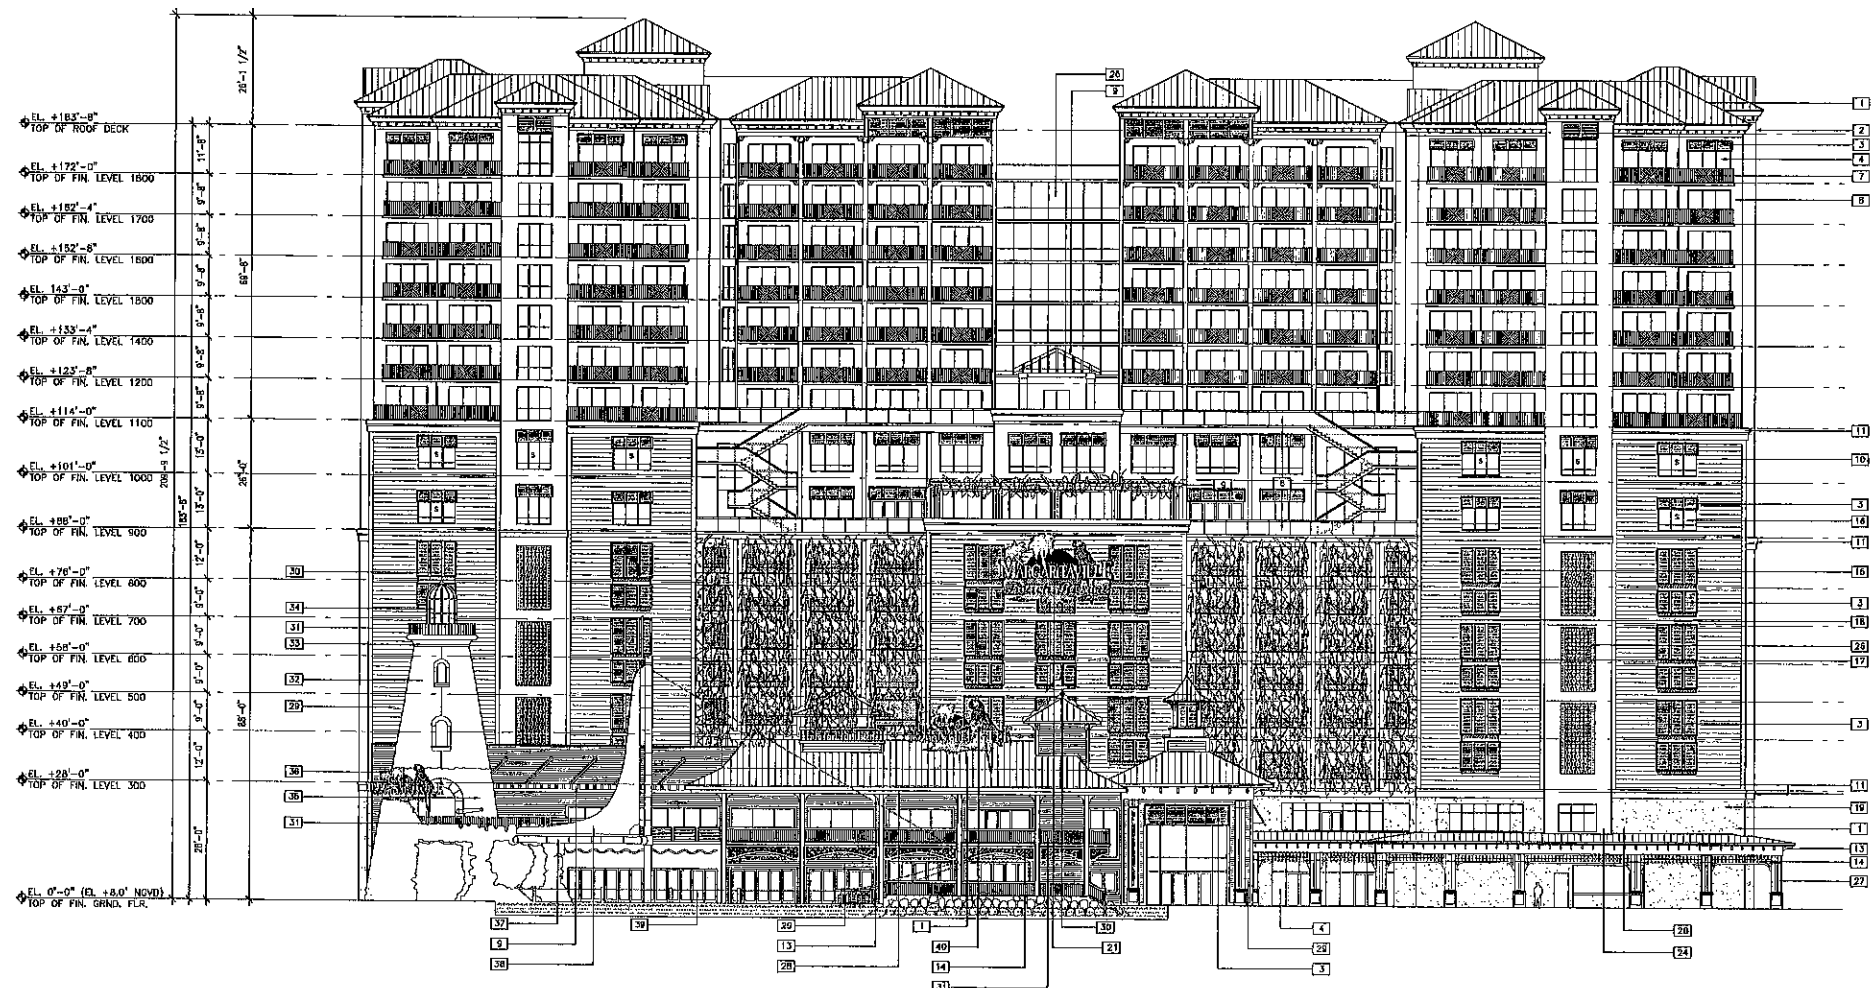

1 EAST EXTERIOR ELEVATION
A-2.1.02 1/16"=1'-0"

GENERAL NOTES

1) CHAPTER 198-55.002 OF THE FLORIDA STATUTES DEFINES UNLEADED GLASS (REGARDING TURTLE CODE) AS "GLASS TREATED TO ACHIEVE AN INDUSTRY APPROVED INSIDE TO OUTSIDE LIGHT TRANSMITTANCE VALUE OF 45% OR LESS". THIS IS NOT THE SAME AS THE GLASS'S SHADING COEFFICIENT. - FOR EXAMPLE, PPG'S SOLARGLASS HAS A LIGHT TRANSMITTANCE OF 44%, HOWEVER ITS SHADING COEFFICIENT IS 0.08.

2) ANY EXTERIOR METAL FRAMING FOR ANY PART OF THE BUILDING ENVELOPE SHALL MEET LARGE MISSILE IMPACT LOWER THAN 30' HIGH AND SMALL MISSILE IMPACT GREATER THAN 30' HIGH.


3) PROVIDE LARGE IMPACT WINDOWS WHERE THERE IS A DROP OF MORE THAN 4'-0" ON THE FAIR SIDE OF SUCH WINDOWS AND THE SILL IS LESS THAN 36" ABOVE THE NEAR SIDE WALKING SURFACE TO ACT AS A SAFEGUARD TO PREVENT THE FALL OF PERSONS WHEN SUCH WINDOWS ARE OPEN.

4) ALL OPERABLE WINDOWS TO HAVE SILLS MINIMUM 36" A.F.F.

5) ALL BALCONIES TO HAVE (SAFEGUARDS) RAILINGS 42" HIGH A.F.F.

6) 'S' ON ELEVATION INDICATED SPANDREL GLASS.

- ELEVATION KEY NOTES:**
- 1) STANDING SEAM METAL ROOF. SEE A-2.1.05 FOR COLOR.
 - 2) WHITE ARCHITECTURAL FOAM MOLDING & BRACKETS TYP. SEE COLOR SWATCH.
 - 3) ALUMINUM BAHAMA SHUTTERS TYPICAL. COLOR: FOUNTAIN BLUE. SEE COLOR SWATCH.
 - 4) WHITE ALUMINUM & GLASS EXTERIOR IMPACT DOORS AND STOREFRONT.
 - 5) WHITE ALUMINUM & GLASS IMPACT FIXED WINDOWS.
 - 6) GLASS RAILINGS WITH WHITE ALUMINUM POSTS AND RAILING.
 - 7) WHITE ALUMINUM PICKET RAILINGS TYPICAL.
 - 8) SMOOTH STUCCO EXTERIOR FINISH. COLOR: WHITE. SEE COLOR SWATCH.
 - 9) WHITE ALUMINUM TRELLIS.
 - 10) TOOLED SMOOTH STUCCO LAP SIDING. COLOR: WHITE. SEE COLOR SWATCH.
 - 11) WHITE ARCHITECTURAL FOAM MOLDING.
 - 12) WHITE ALUMINUM BRACKET.
 - 13) WHITE ALUMINUM DECORATIVE BRACKETS TYPICAL.
 - 14) WHITE ALUMINUM DECORATIVE OPEN LATTICE.
 - 15) OPEN TO GARAGE WITH WHITE ALUMINUM WINDOW FRAME (NO GLASS).
 - 16) SPANDREL GLASS.
 - 17) EXTERIOR CONCRETE PLANTER. FINISH: WHITE SMOOTH STUCCO.
 - 18) WHITE ALUMINUM VERTICAL TRELLIS FOR SCANDOLA.
 - 19) TABBY COQUINA SHELL STUCCO. COLOR: SEE COLOR SWATCH.
 - 20) FALSE BALCONY FRENCH RAILING.
 - 21) SIGNAGE: 27'-0" W X 20'-0" H (300 SF).
 - 22) FOUNTAIN WATER FEATURE.
 - 23) FLAG POLES.
 - 24) WHITE ALUMINUM FIXED SHUTTERS.
 - 25) WHITE ALUMINUM AND GLASS EXTERIOR FIXED GLAZING.
 - 26) WHITE ALUMINUM DECORATIVE OPEN LATTICE. OPEN TO GARAGE BEYOND.
 - 27) WHITE DECORATIVE COLUMNS TYPICAL.
 - 28) WHITE ALUMINUM FASCIA.
 - 29) HARD PLANK LAP SIDING. COLOR: WHITE. SEE COLOR SWATCH.
 - 30) DECORATIVE FINIAL.
 - 31) DECORATIVE WHITE ALUMINUM PICKET RAILINGS.
 - 32) CORAL ROCK FINISH.
 - 33) CAST CONCRETE CAP.
 - 34) WHITE ALUMINUM & GLASS FIXED WINDOWS.
 - 35) ROUGH CORAL ROCK FINISH.
 - 36) SIGNAGE: 17'-0" W X 12'-0" H (100 SF).
 - 37) CLEAR ANODIZED ALUMINUM DECORATIVE SHIP MAST.
 - 38) DECORATIVE WHITE CANVAS SAIL.
 - 39) OUTLINE OF DECORATIVE FEATURE SHIP IN FOREGROUND. NOT SHOWN FOR CLARITY.
 - 40) SIGNAGE: 17'-0" W X 12'-0" H (100 SF).
 - 41) NATURAL ROCK FORMATIONS.

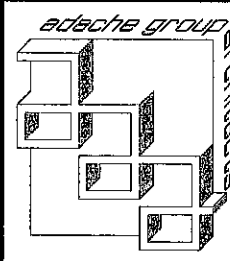

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HOLLYWOOD, FLORIDA 33319



300 JOHNSON STREET
HOLLYWOOD BEACH, FLORIDA

ISSUED FOR: TAC FINAL
DATE: 10/29/2010


REVISIONS:		
No.	DATE	REMARKS

SHEET TITLE:
EXTERIOR ELEVATION

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DATE: 10/29/2010
SCALE: 1/16"=1'-0"
DRAWN BY: JR
CHECKED BY: JB
JOB NO.: 84.08A

SHEET NO.:
A-2.1.03

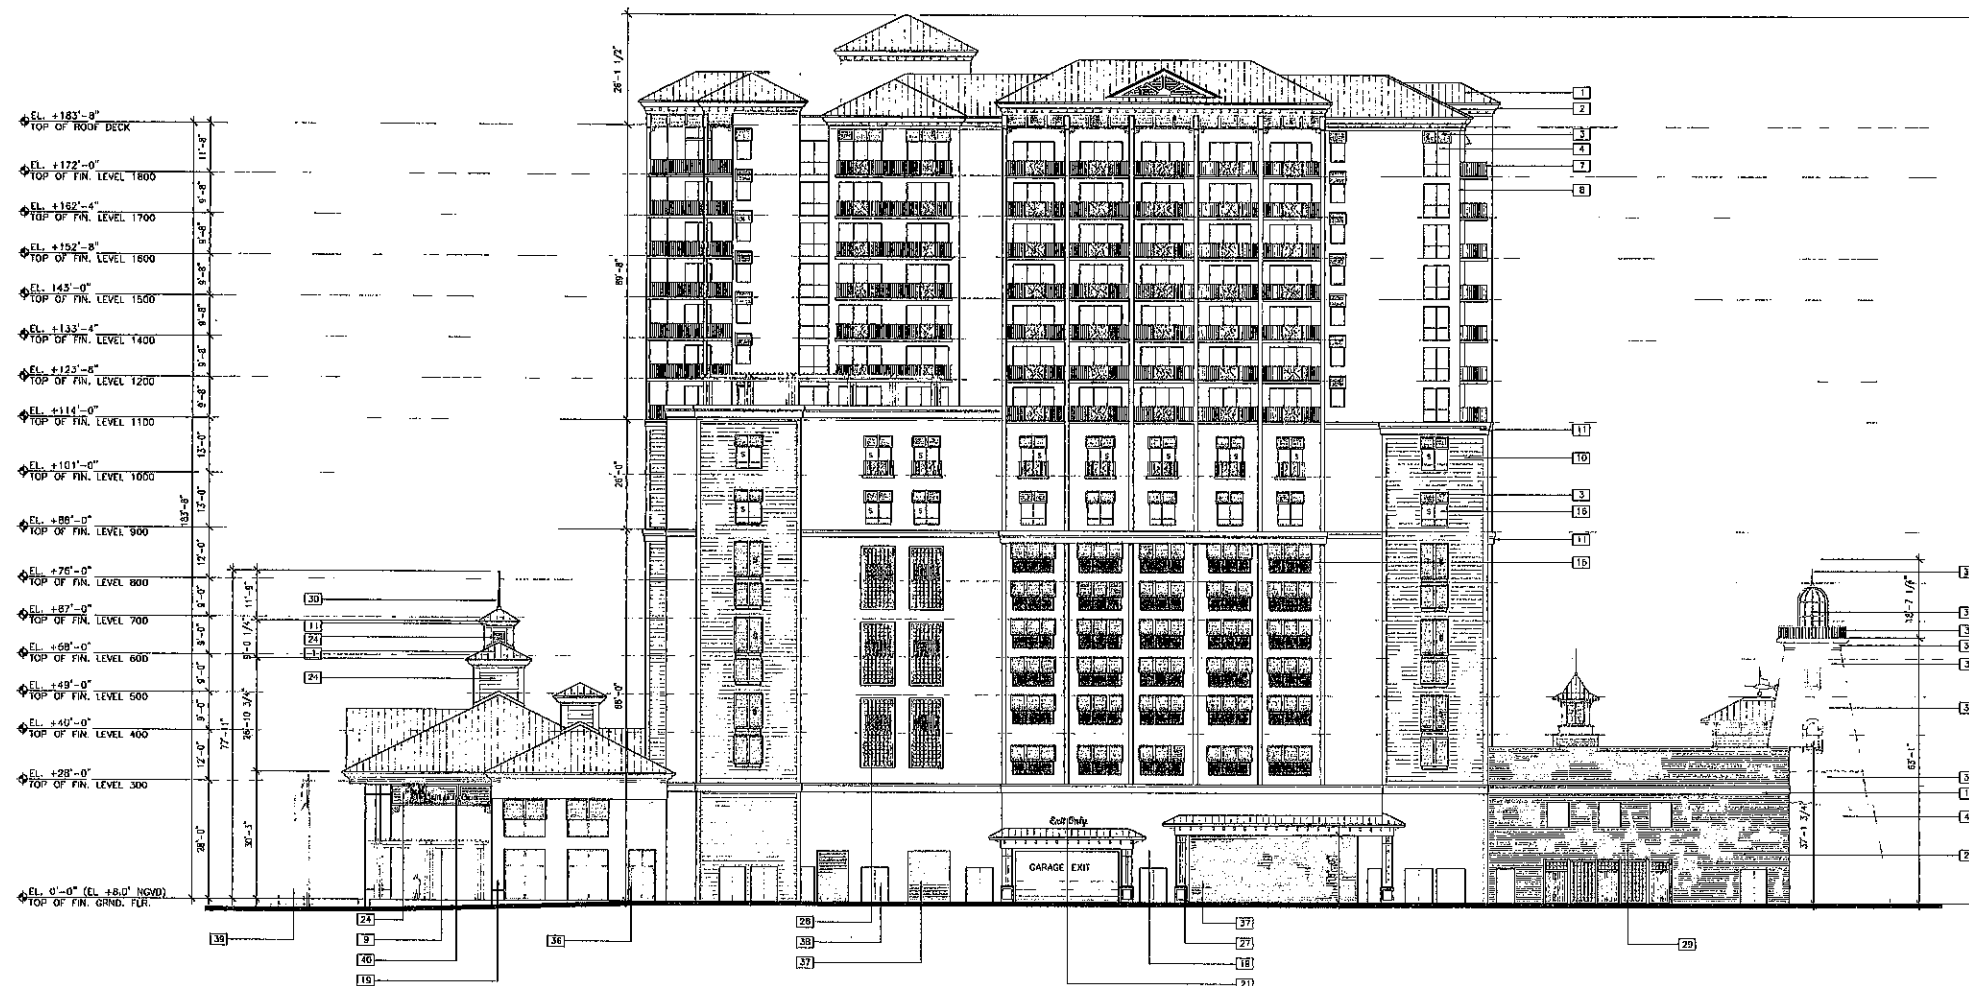


1 SOUTH EXTERIOR ELEVATION
A-2.1.03 1/16"=1'-0"

GENERAL NOTES

- CHAPTER 108-55.002 OF THE FLORIDA STATUTES DEFINES TINTED GLASS (REGARDING TINTED GLASS) AS "GLASS TREATED TO ACHIEVE AN INDUSTRY APPROVED INSIDE TO OUTSIDE LIGHT TRANSMITTANCE VALUE OF 45% OR LESS". THIS IS NOT THE SAME AS THE GLASS'S SHADING COEFFICIENT. - FOR EXAMPLE, PPG'S SOLARBROWN HAS A LIGHT TRANSMITTANCE OF 44%, HOWEVER ITS SHADING COEFFICIENT IS 0.66.
- ANY EXTERIOR METAL FRAMING FOR ANY PART OF THE BUILDING ENVELOPE SHALL MEET LARGE MISSILE IMPACT LOWER THAN 30" HIGH AND SMALL MISSILE IMPACT GREATER THAN 30" HIGH.
- PROVIDE LARGE IMPACT WINDOWS WHERE THERE IS A DROP OF MORE THAN 4'-0" ON THE FAR SIDE OF SUCH WINDOWS AND THE SILL IS LESS THAN 36" ABOVE THE NEAR SIDE WALKING SURFACE TO ACT AS A SAFEGUARD TO PREVENT THE FALL OF PERSONS WHEN SUCH WINDOWS ARE OPEN.
- ALL OPERABLE WINDOWS TO HAVE SELLS MINIMUM 3/8" A.F.F.
- ALL BALCONIES TO HAVE (SAFEGUARDS) RAILINGS 42" HIGH A.F.F.
- 5' ON ELEVATION INDICATED SPANDREL GLASS.

ELEVATION KEY NOTES:

- STANDING SEAM METAL ROOF. SEE A-2.1.05 FOR COLOR.
- WHITE ARCHITECTURAL FOAM MOLDING & BRACKETS TYP. SEE COLOR SWATCH.
- ALUMINUM BAHAMA SHUTTERS TYPICAL. COLOR: FOUNTAIN BLUE. SEE COLOR SWATCH.
- WHITE ALUMINUM & GLASS EXTERIOR IMPACT DOORS AND STOREFRONT.
- WHITE ALUMINUM & GLASS IMPACT FIXED WINDOWS.
- GLASS RAILING WITH WHITE ALUMINUM POSTS AND RAILING.
- WHITE ALUMINUM PICKET RAILINGS TYPICAL.
- SMOOTH STUCCO EXTERIOR FINISH. COLOR: WHITE. SEE COLOR SWATCH.
- WHITE ALUMINUM TRELLIS.
- FOOKED SMOOTH STUCCO LAP SIDING. COLOR: WHITE. SEE COLOR SWATCH.
- WHITE ARCHITECTURAL FOAM MOLDING.
- WHITE ALUMINUM BRACKET.
- WHITE ALUMINUM DECORATIVE BRACKETS TYPICAL.
- WHITE ALUMINUM DECORATIVE OPEN LATTICE.
- OPEN TO GARAGE WITH WHITE ALUMINUM WINDOW FRAME (NO GLASS).
- SPANDREL GLASS.
- EXTERIOR CONCRETE PLANTER. FINISH: WHITE SMOOTH STUCCO.
- WHITE ALUMINUM VERTICAL TRELLIS FOR SCANDOLA.
- TABBY COQUINA SHELL STUCCO. COLOR: SEE COLOR SWATCH.
- FALSE BALCONY FRENCH RAILING.
- SIGNAGE: 9'-5"W X 2'-8"H (26 SF).
- FOUNTAIN WATER FEATURE.
- FLAG POLES.
- WHITE ALUMINUM FIXED SHUTTERS.
- WHITE ALUMINUM AND GLASS EXTERIOR FIXED GLAZING.
- WHITE ALUMINUM DECORATIVE OPEN LATTICE. OPEN TO GARAGE BEYOND.
- WHITE DECORATIVE COLUMNS TYPICAL.
- WHITE ALUMINUM FASCIA.
- HARDY PLANK LAP SIDING. COLOR: WHITE. SEE COLOR SWATCH.
- DECORATIVE FINIAL.
- DECORATIVE WHITE ALUMINUM PICKET RAILINGS.
- CORAL ROCK FINISH.
- CAST CONCRETE CAP.
- WHITE ALUMINUM & GLASS FIXED WINDOWS.
- ROUGH CORAL ROCK FINISH.
- LANDSCAPED TRELLIS.
- ANODIZED ALUMINUM ROLL DOWN DOOR.
- HOLLOW METAL DOORS PAINTED TO MATCH TABBY STUCCO.
- MONUMENT SIGN 8'-0"W X 6'-0"H (48 SF).
- SIGNAGE: 17'-0"W X 5'-0"H (26 SF).
- NATURAL ROCK FORMATIONS.

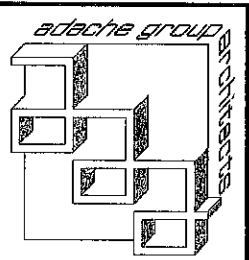

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HOLLYWOOD, FLORIDA 33019



SEAL:

ISSUED FOR: TAC FINAL
DATE: 10/29/2010


REVISIONS:		
No.	DATE	REMARKS

SHEET TITLE:
EXTERIOR ELEVATION

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DATE:
SCALE: 1/16"=1'-0"
DRAWN BY: JR
CHECKED BY: JB
JOB NO.: 94.08A

SHEET NO.:
A-2.1.04

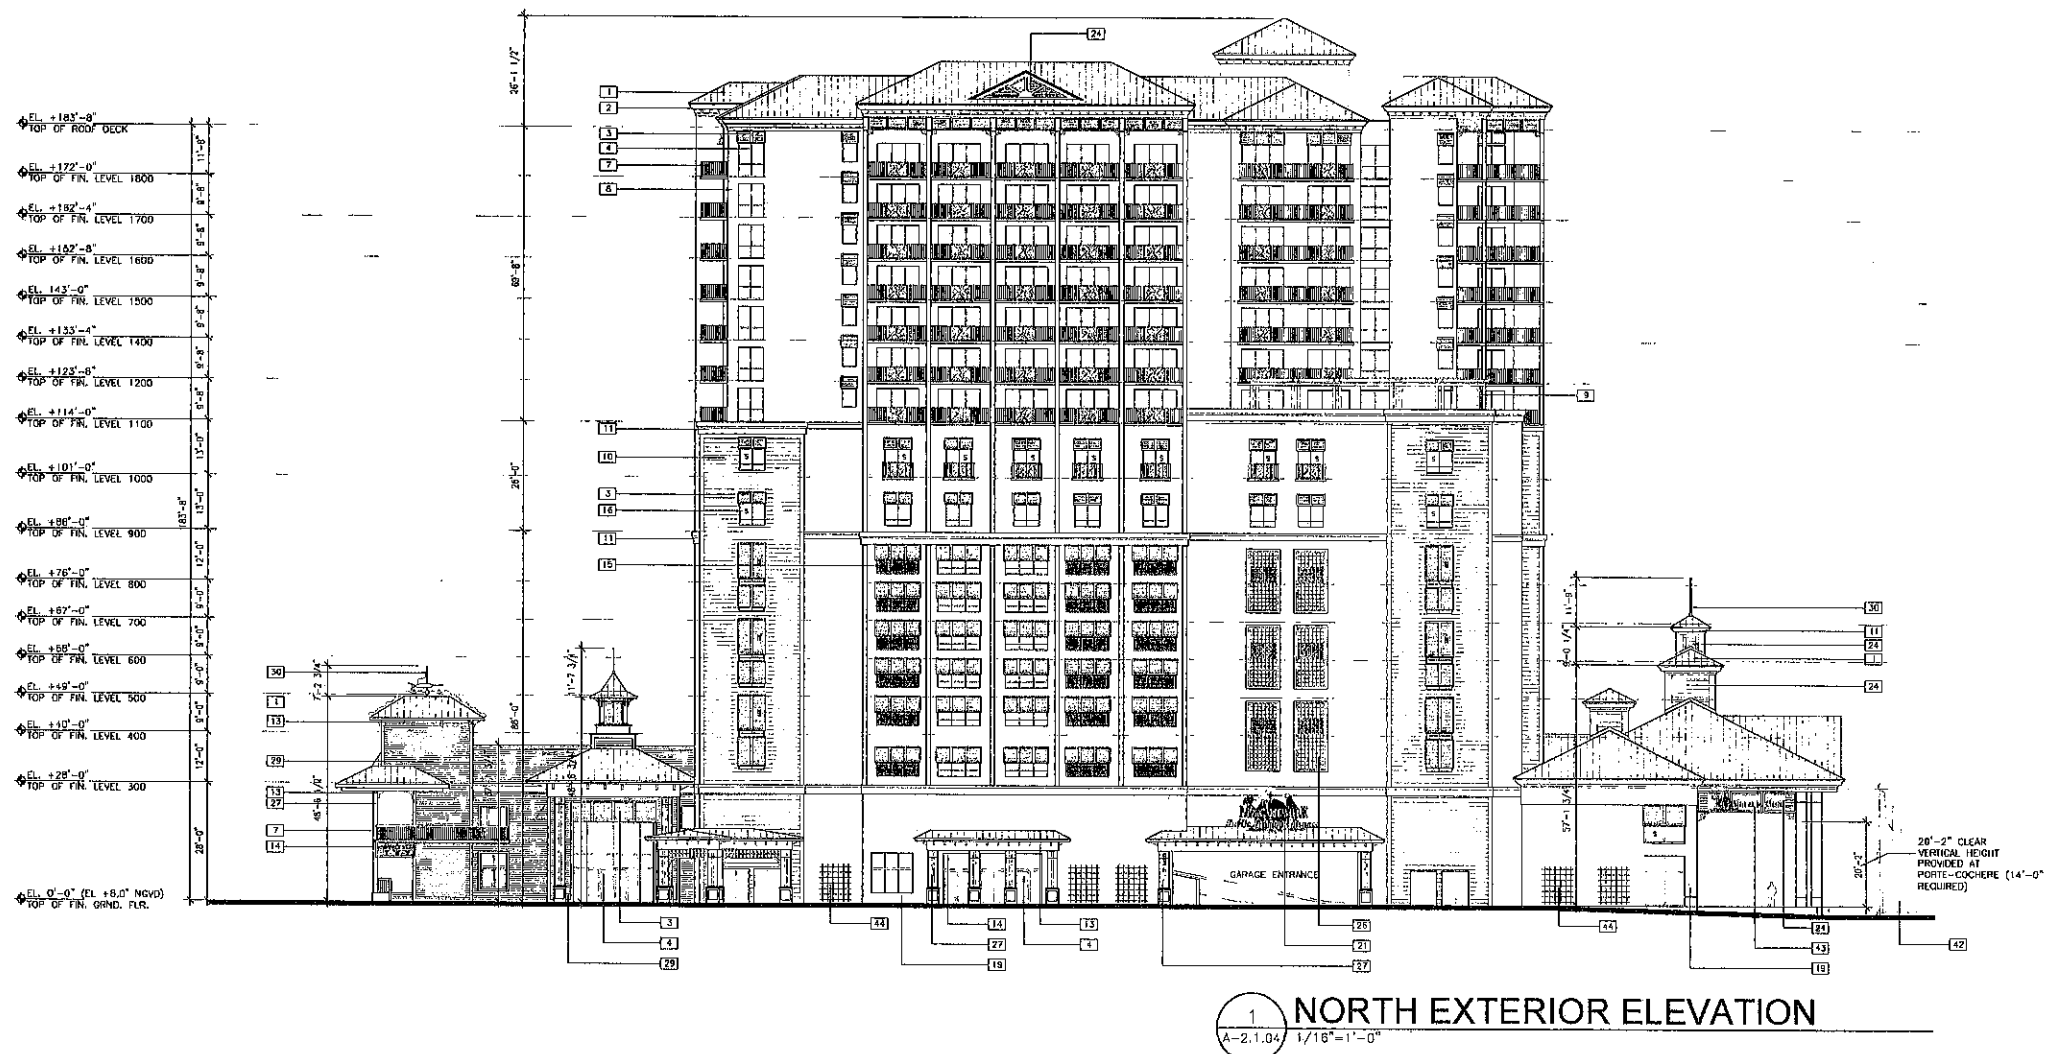

GENERAL NOTES

1) CHAPTER 108-52.002 OF THE FLORIDA STATUTES DEFINES TINTED GLASS (REGARDING TINTLE CODE) AS "GLASS TREATED TO ACHIEVE AN INDUSTRY APPROVED, INSIDE TO OUTSIDE LIGHT TRANSMITTANCE VALUE OF 45% OR LESS". THIS IS NOT THE SAME AS THE GLASS'S SHADING COEFFICIENT - FOR EXAMPLE, PPG'S SOLARGRAY HAS A LIGHT TRANSMITTANCE OF 44%, HOWEVER ITS SHADING COEFFICIENT IS 0.66.

2) ANY EXTERIOR METAL FRAMING FOR ANY PART OF THE BUILDING ENVELOPE SHALL MEET LARGE MISSILE IMPACT LOWER THAN 30" HIGH AND SHALL MISSILE IMPACT GREATER THAN 30" HIGH.

3) PROVIDE LARGE IMPACT WINDOWS WHERE THERE IS A DROP OF MORE THAN 4'-0" ON THE FAR SIDE OF SUCH WINDOWS AND THE SILL IS LESS THAN 36" ABOVE THE NEAR SIDE WALKING SURFACE TO ACT AS A SAFEGUARD TO PREVENT THE FALL OF PERSONS WHEN SUCH WINDOWS ARE OPEN.

4) ALL OPERABLE WINDOWS TO HAVE SILLS MINIMUM 36" A.F.F.

5) ALL BALCONIES TO HAVE (SAFEGUARDS) RAILINGS 42" HIGH A.F.F.


6) 'S' ON ELEVATION INDICATED SPANDREL GLASS.

- ELEVATION KEY NOTES:**
- | | | | | |
|--|--|--|--|--|
| 1) STANDING SEAM METAL ROOF. SEE A-2.1.05 FOR COLOR. | 10) TOOLED SMOOTH STUCCO LAP SIDING. COLOR: WHITE. SEE COLOR SWATCH. | 19) TARRY COQUINA SHELL STUCCO. COLOR: SEE COLOR SWATCH. | 28) WHITE ALUMINUM FASCIA. | 37) CLEAR ANODIZED ALUMINUM DECORATIVE SHIP MAST. |
| 2) WHITE ARCHITECTURAL FOAM MOLDING & BRACKETS TYP. SEE COLOR SWATCH. | 11) WHITE ARCHITECTURAL FOAM MOLDING. | 20) FALSE BALCONY FRENCH RAILING. | 29) HARD PLANK LAP SIDING. COLOR: WHITE. SEE COLOR SWATCH. | 38) DECORATIVE WHITE CANVAS SAIL. |
| 3) ALUMINUM BANANA SHUTTERS TYPICAL. COLOR: FOUNTAIN BLUE. SEE COLOR SWATCH. | 12) WHITE ALUMINUM BRACKET. | 21) SIGNAGE: 22'-2"W X 10'-2"H (230 SF). | 30) DECORATIVE FINIAL. | 39) OUTLINE OF DECORATIVE FEATURE SHIP IN FOREGROUND. NOT SHOWN FOR CLARITY. |
| 4) WHITE ALUMINUM & GLASS EXTERIOR IMPACT DOORS AND STOREFRONT. | 13) WHITE ALUMINUM DECORATIVE BRACKETS TYPICAL. | 22) FOUNTAIN WATER FEATURE. | 31) DECORATIVE WHITE ALUMINUM PICKET RAILINGS. | 40) ANODIZED ALUMINUM ROLL DOWN DOOR. |
| 5) WHITE ALUMINUM & GLASS IMPACT FIXED WINDOWS. | 14) WHITE ALUMINUM DECORATIVE OPEN LATTICE. | 23) FLAG POLES. | 32) CORAL ROCK FINISH. | 41) HOLLOW METAL DOORS PAINTED TO MATCH TARRY STUCCO. |
| 6) GLASS RAILING WITH WHITE ALUMINUM POSTS AND RAILING. | 15) OPEN TO GARAGE WITH WHITE ALUMINUM WINDOW FRAME (NO GLASS). | 24) WHITE ALUMINUM FIXED SHUTTERS. | 33) DECORATIVE WHITE ALUMINUM BRACKET. | 42) MONUMENT SIGN 8'-0"W X 6'-0"H (48 SF). |
| 7) WHITE ALUMINUM PICKET RAILINGS TYPICAL. | 16) SPANDREL GLASS. | 25) WHITE ALUMINUM AND GLASS EXTERIOR FIXED CLAZING. | 34) WHITE ALUMINUM & GLASS FIXED WINDOWS. | 43) SIGNAGE 17'-0"W X 5'-0"H (25 SF). |
| 8) SMOOTH STUCCO EXTERIOR FINISH. COLOR: WHITE. SEE COLOR SWATCH. | 17) EXTERIOR CONCRETE PLANTER. FINISH: WHITE SMOOTH STUCCO. | 26) WHITE ALUMINUM DECORATIVE OPEN LATTICE. OPEN TO GARAGE BEYOND. | 35) SILVER/TIN COLOR METAL ROOF. | 44) VERTICAL ALUMINUM PLANTER TRELLIS SEE DETAIL 6/A-1.1.03. |
| 9) WHITE ALUMINUM TRELLIS. | 18) WHITE ALUMINUM VERTICAL TRELLIS FOR SCAYOLA. | 27) WHITE DECORATIVE COLUMNS TYPICAL. | 36) LANDSCAPED TRELLIS. | |




NORTH ELEVATION

- BODY COLOR: SW600 WHITE, SNOWFALL LRV 74% SW 6113
- ACCENT COLOR: POPULAR GRAY SW 6071
- TABBY COQUINA: SHELL STUCCO
- ACCENT COLOR: LIQUID BLUE SW 6779
- STANDING SEAM ROOF/SHUTTERS: COLOR: SLATE BLUE
- STANDING SEAM ROOF: COLOR: BRIGHT SILVER

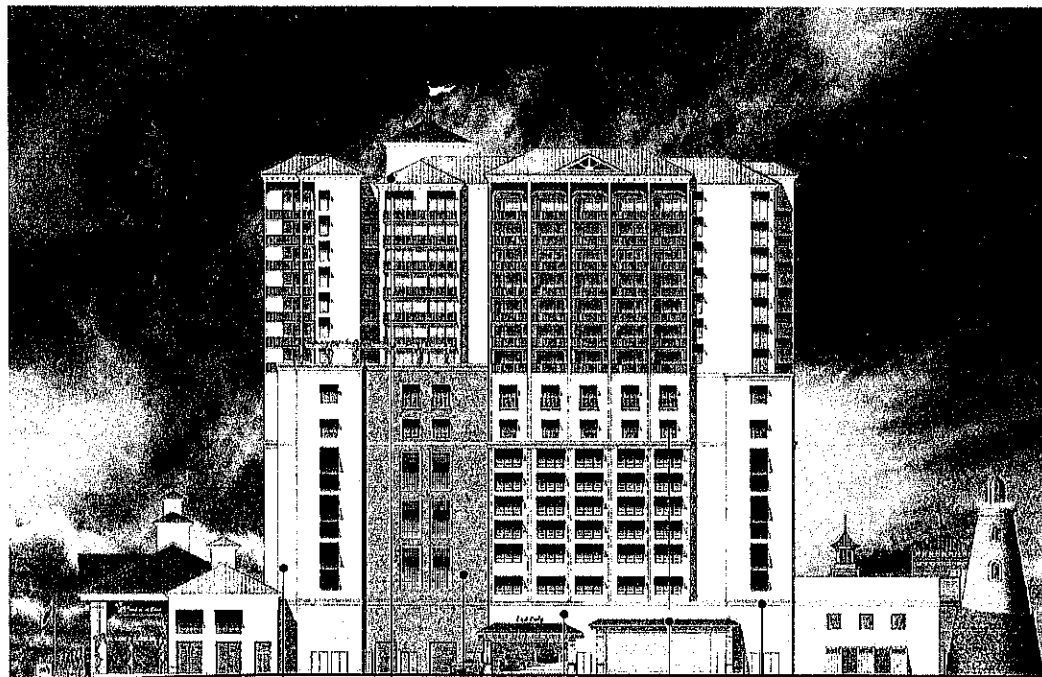


SOUTH ELEVATION

- BODY COLOR: SW600 WHITE, SNOWFALL LRV 74% SW 6113
- STANDING SEAM ROOF: COLOR: BRIGHT SILVER
- ACCENT COLOR: LIQUID BLUE SW 6779
- TABBY COQUINA: SHELL STUCCO
- STANDING SEAM ROOF/SHUTTERS: COLOR: SLATE BLUE
- ACCENT COLOR: POPULAR GRAY SW 6071

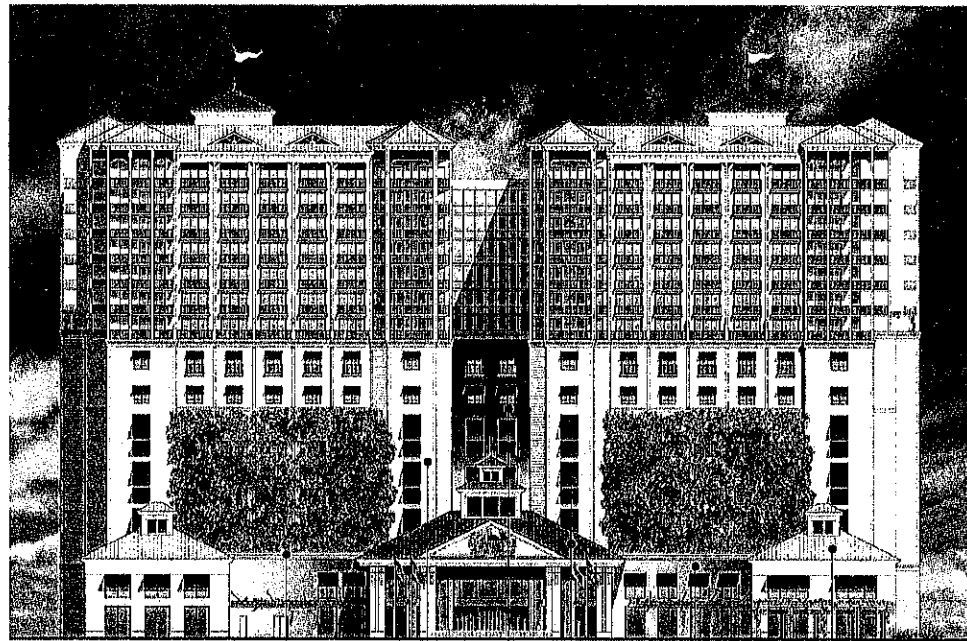


WEST ELEVATION

- ACCENT COLOR: POPULAR GRAY SW 6071
- BODY COLOR: SW600 WHITE, SNOWFALL LRV 74% SW 6113
- GRADIENT PAINTS: PMS VIOLET, PMS YELLOW, PMS PURPLE, PMS RED 032, PMS ORANGE 021
- STANDING SEAM ROOF/SHUTTERS: COLOR: SLATE BLUE
- TABBY COQUINA: SHELL STUCCO
- STANDING SEAM ROOF: COLOR: BRIGHT SILVER

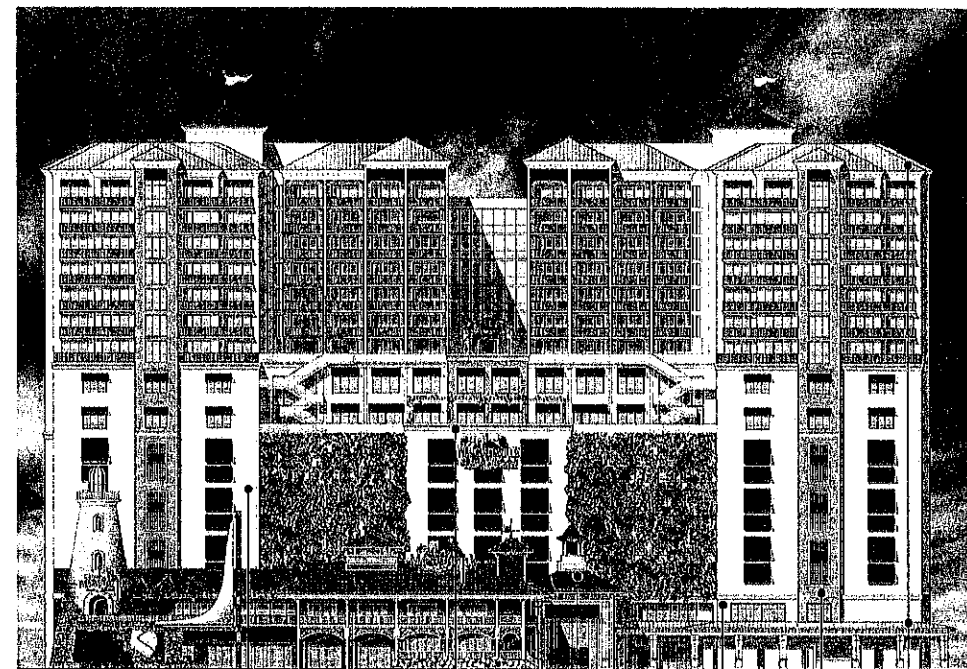

EAST ELEVATION

- BODY COLOR: SW600 WHITE, SNOWFALL LRV 74% SW 6113
- ACCENT COLOR: SMOKEY TOPAZ SW 6117
- ACCENT COLOR: POPULAR GRAY SW 6071
- STANDING SEAM ROOF/SHUTTERS: COLOR: SLATE BLUE
- TABBY COQUINA: SHELL STUCCO
- ACCENT COLOR: LIQUID BLUE SW 6779
- STANDING SEAM ROOF: COLOR: BRIGHT SILVER

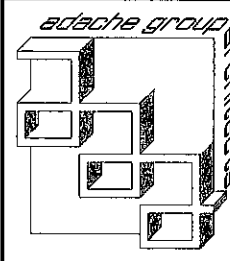

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OWNER:
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 BEACH RESORT, LLC
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 HOLLYWOOD, FLORIDA 33019



SEAL:

ISSUED FOR: TAC FINAL
DATE: 10/28/2010

NO.	DATE	REMARKS

SHEET TITLE:
 COLOR EXTERIOR
 ELEVATION


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DATE:
SCALE: 1/16"=1'-0"
DRAWN BY: JR
CHECKED BY: JB
JOB NO.: 94.08A

SHEET NO.:
A-2.1.05



WEST ELEVATION RENDERING

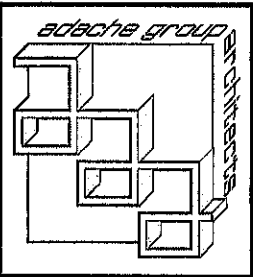

PROJECT DESIGN TEAM:
ARCHITECTS
ADACHE GROUP ARCHITECTS
100 W. 10th Street, Suite 100
LAUREL, FLORIDA 33041
PH: (904) 875-8100 FAX: (904) 875-8100
E-MAIL: info@adache.com
CREATIVE DESIGNER
PAT MCBRIDE CO.
11 BAYVIEW DRIVE
LAUREL, FLORIDA 33041
PH: (904) 875-8100 FAX: (904) 875-8100
E-MAIL: pat@mcbrideco.com
M.E.P. ENGINEER
TWO ENGINEERS
8000 N. W. 10th Street
LAUREL, FLORIDA 33041
PH: (904) 875-8100 FAX: (904) 875-8100
E-MAIL: two@twoengineers.com
STRUCTURAL ENGINEER
TRC WORLDWIDE ENGINEERING
3000 W. 10th Street
FORT LAUDERDALE, FLORIDA 33304
(954) 444-7777 FAX: (954) 444-7777
CIVIL ENGINEER
CONSULTING ENGINEERING & SCIENCE, INC.
10000 N. W. 10th Street, Suite 400
MIAMI, FLORIDA 33158
(305) 578-5155 FAX: (305) 578-5155

OWNER: MARGARITAVILLE HOLLYWOOD
BEACH RESORT, LLC
3501 N. OCEAN DRIVE
HOLLYWOOD, FLORIDA 33019



SEAL:

ISSUED FOR: TAC FINAL
DATE: 10/29/2010


REVISIONS:		
No.	DATE	REMARKS

SHEET TITLE:
EXTERIOR ELEVATION
RENDERING


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FLORIDA LICENSE # AFW007073

DATE:
SCALE:
DRAWN BY: JR
CHECKED BY: JB
JOB NO.: 94.08A

SHEET NO.:
R-1.01

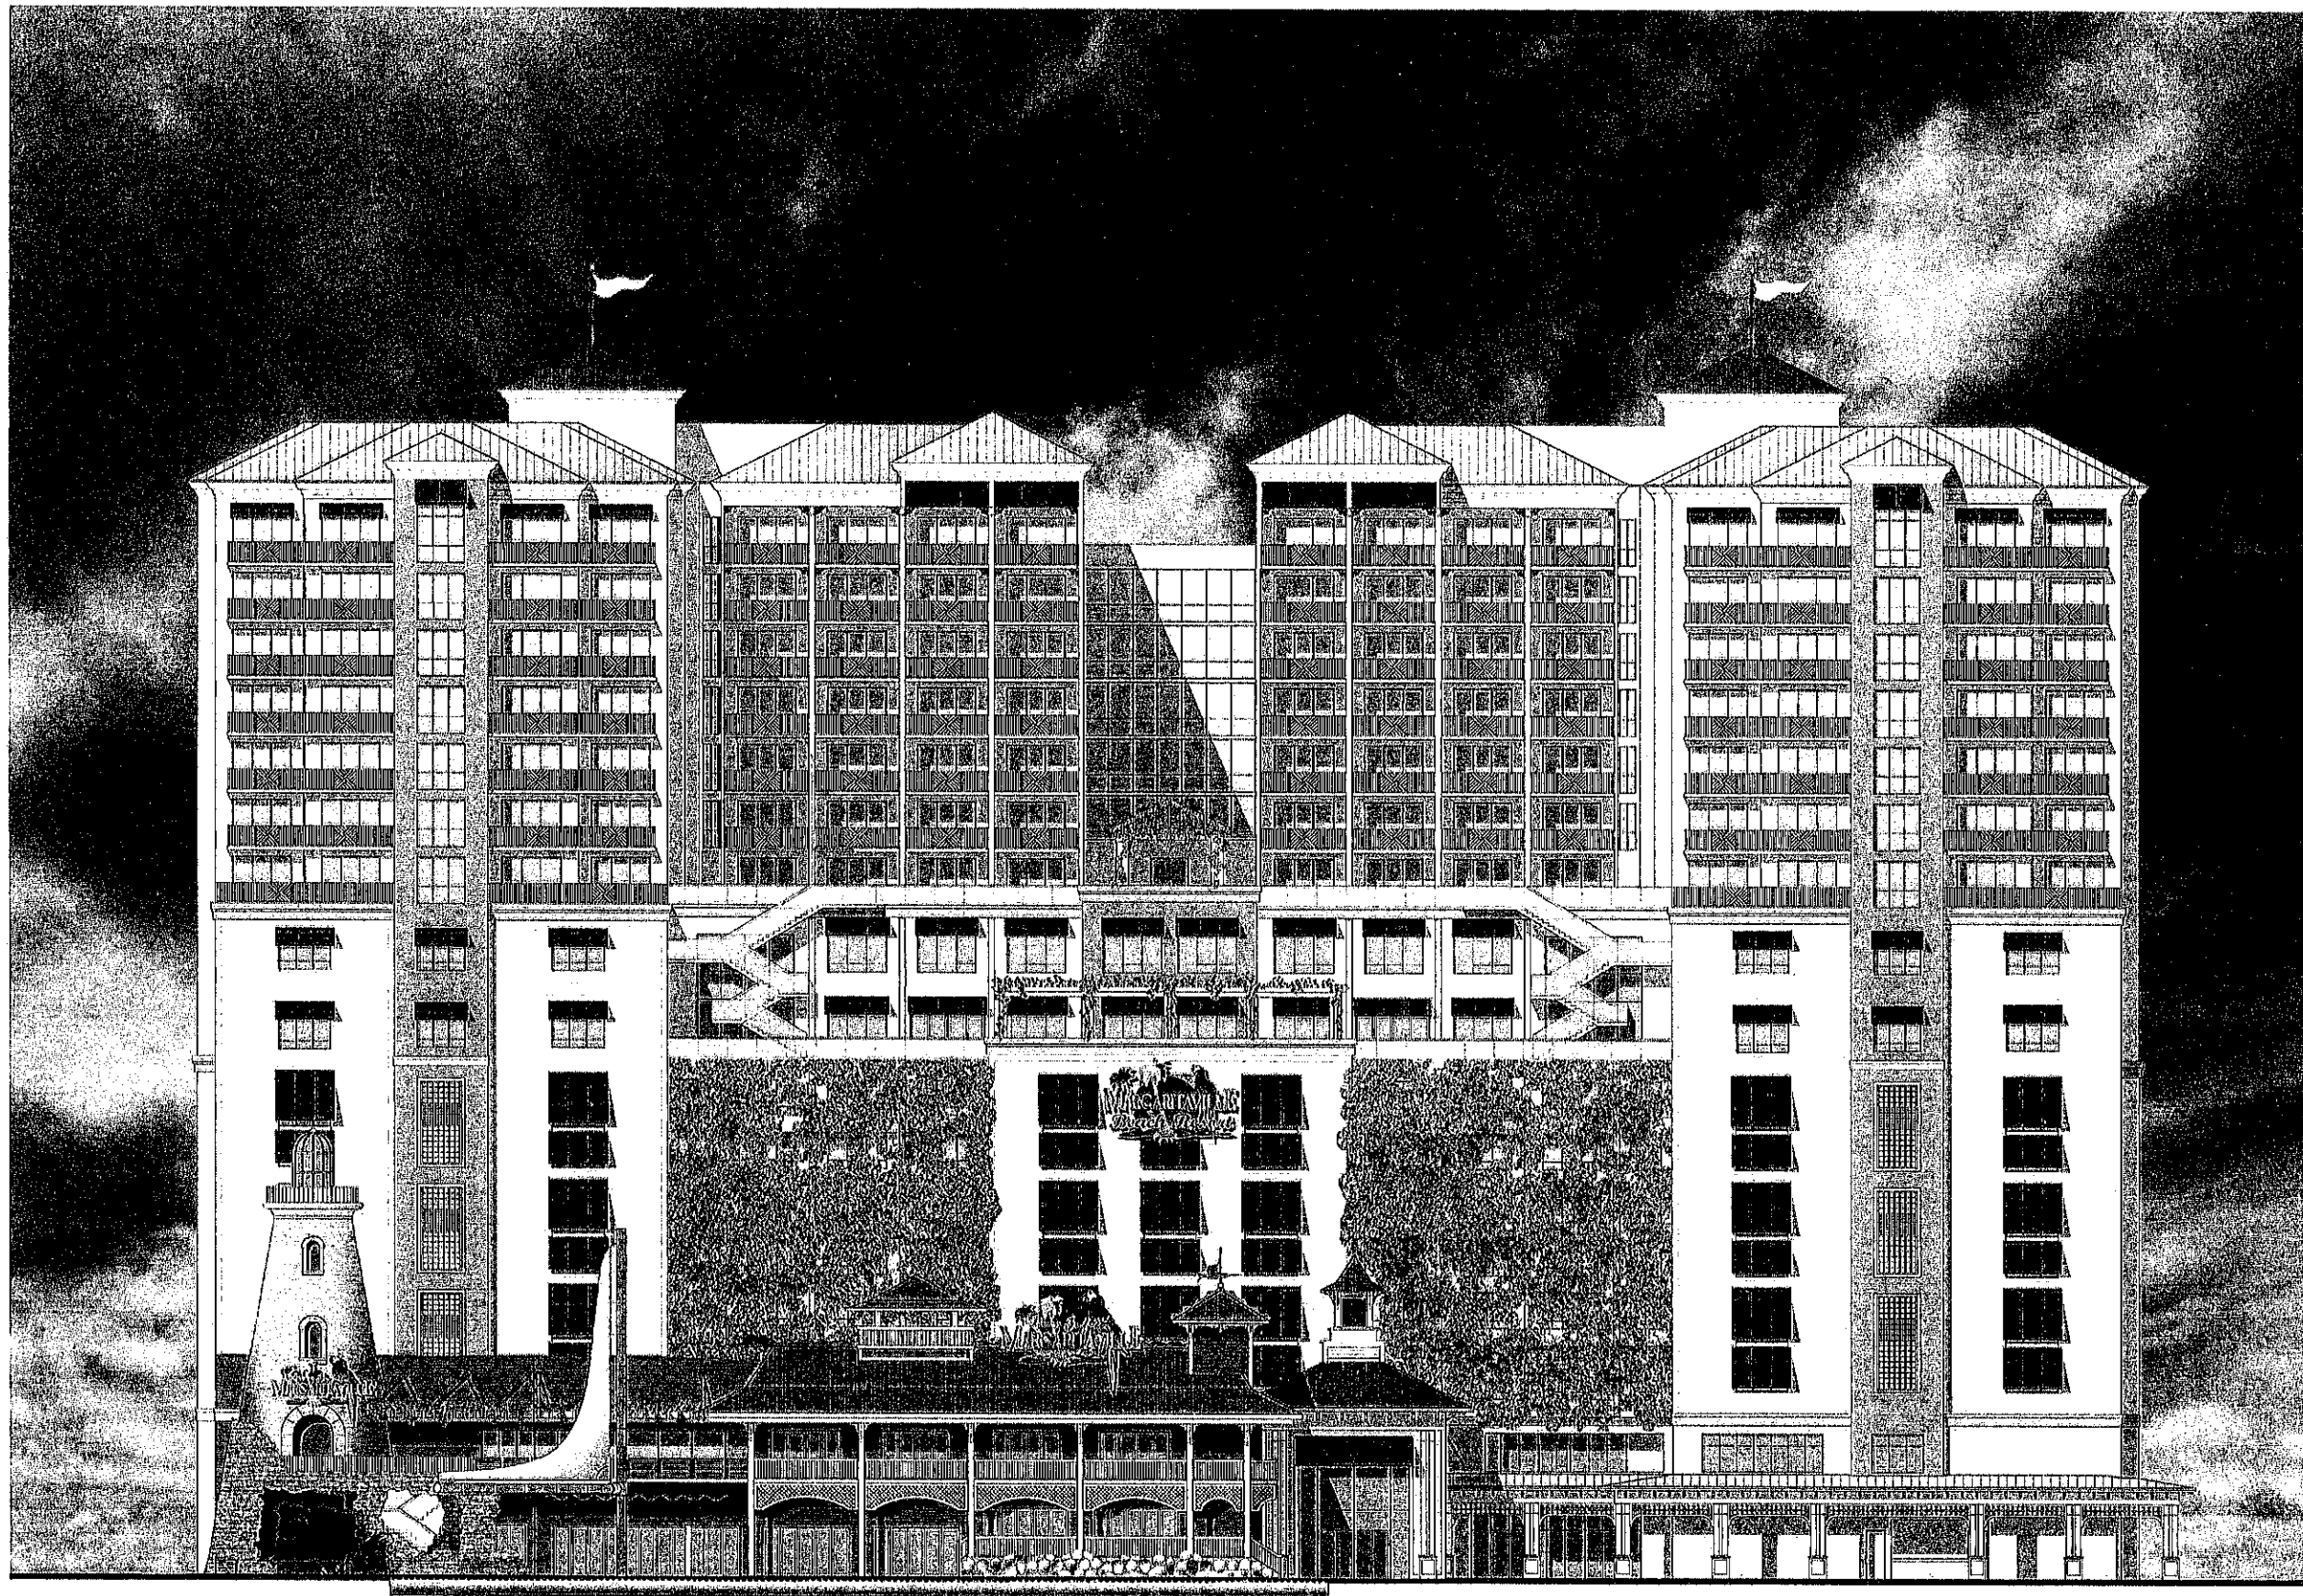

EAST ELEVATION RENDERING

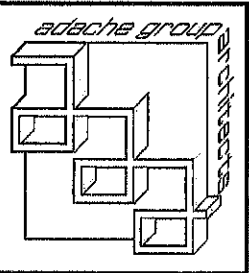

PROJECT DESIGN TEAM:
ARCHITECTS
ADACHE GROUP ARCHITECTS
600 SOUTH FEDERAL HIGHWAY #1
FORT LAUDERDALE, FLORIDA 33304
PH: (954) 425-4133 FAX: (954) 425-4138
E-MAIL: info@adachegroup.com
CREATIVE DESIGNER
PAT MCBRIDE CO.
11 DANIEL PARR RD.
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PH: (802) 878-2277 FAX: (802) 878-0700
E-MAIL: info@mcbrideco.com
M.E.P. ENGINEER
TWR ENGINEERS
8000 S. DIXIE AVE. SUITE 200
FORT LAUDERDALE, FLORIDA 33304
PH: (954) 571-9800 FAX: (954) 571-9800
E-MAIL: info@twr-engineers.com
STRUCTURAL ENGINEER
TWO WORLDWIDE ENGINEERING
2556 NW 25 STREET
FORT LAUDERDALE, FLORIDA 33309
PH: (954) 777-7777 FAX: (954) 498-7134
CIVIL ENGINEER
CONSULTING ENGINEERS & SCIENCE, INC.
10700 MEDICAL DRIVE, SUITE 400
FORT LAUDERDALE, FLORIDA 33304
PH: (954) 578-9600 FAX: (954) 578-4552

OWNER:
MARGARITAVILLE HOLLYWOOD
BEACH RESORT, LLC.
3501 N. OCEAN DRIVE
HOLLYWOOD, FLORIDA 33019



300 JOHNSON STREET
HOLLYWOOD BEACH, FLORIDA

ISSUED FOR: TAC FINAL
DATE: 10/29/2010

REVISIONS:		
No.	DATE	REMARKS

SHEET TITLE:
EXTERIOR ELEVATION
RENDERING


ALL IDEAS, DESIGNS, ARRANGEMENTS, PLANS AND SPECIFICATIONS INDICATED OR REPRESENTED BY THIS DRAWING ARE OWNED BY, AND THE PROPERTY OF, ADACHE GROUP ARCHITECTS, INC. AND WERE CREATED, EVOLVED AND DEVELOPED FOR USE ON, AND IN CONNECTION WITH, THE SPECIFIC PROJECT, NONE OF THESE IDEAS, PLANS, ARRANGEMENTS, AND SPECIFICATIONS SHALL BE USED BY OR FOR ANY PERSON, CORPORATION OR FIRM FOR ANY PURPOSE WHATSOEVER WITHOUT THE WRITTEN PERMISSION OF ADACHE GROUP ARCHITECTS. VISUAL CONTACT WITH THESE PLANS OR SPECIFICATIONS SHALL CONSTITUTE CONCLUSIVE EVIDENCE OF ACCEPTANCE OF THESE RESTRICTIONS. ALL RIGHTS RESERVED. © 2010
FLORIDA LICENSE # AR0007073

DATE:
SCALE:
DRAWN BY: JR
CHECKED BY: JB
JOB NO.: 04.00A

SHEET NO.:
R-1.02



SOUTH ELEVATION RENDERING

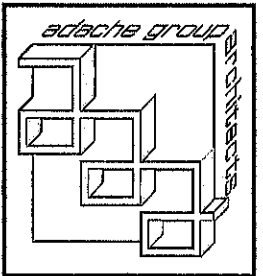

PROJECT DESIGN TEAM:
ARCHITECTS
ADACHE GROUP ARCHITECTS
600 SOUTH FEDERAL HIGHWAY, 11TH FLOOR
LAUDERDALE, FLORIDA 33301
PH: (954) 450-8223 FAX: (954) 739-8199
E-MAIL: info@adachegroup.com
CREATIVE DESIGNER
PAT MCBRIDE CO.
11400 E. 14TH AVE.
MANCHESTER CENTER, VT. 05255
PH: (802) 875-2075 FAX: (802) 861-0700
E-MAIL: pat@mcbrideco.com
M.E.P. ENGINEER
TWR ENGINEERS
3000 N.W. 10TH AVE., SUITE 100
MIAMI, FLORIDA 33136
PH: (305) 476-0330 FAX: (305) 476-0330
E-MAIL: twr@twr-engineers.com
STRUCTURAL ENGINEER
TRC WORLDWIDE ENGINEERING
3000 N.W. 10TH AVE., SUITE 100
MIAMI, FLORIDA 33136
PH: (305) 476-0330 FAX: (305) 476-0330
E-MAIL: trc@trc-engineers.com
CIVIL ENGINEER
CONSULTING ENGINEERING & SCIENCE, INC.
10700 N.W. 10TH AVE., SUITE 400
MIAMI, FLORIDA 33157
PH: (305) 578-1500 FAX: (305) 578-1505

OWNER:
MARGARITAVILLE HOLLYWOOD
BEACH RESORT, LLC
3801 N. OCEAN DRIVE
HOLLYWOOD, FLORIDA 33019



SEAL:

ISSUED FOR: TAC FINAL
DATE: 10/29/2010

REVISIONS:		
No.	DATE	REMARKS

SHEET TITLE:
EXTERIOR ELEVATION
RENDERING


ALL IDEAS, DESIGN, ARRANGEMENTS, PLANS AND SPECIFICATIONS INDICATED OR REPRESENTED BY THIS DRAWING ARE OWNED BY, AND THE PROPERTY OF, ADACHE GROUP ARCHITECTS, INC. AND WILL BE CREATED, ENJOINED AND DEVELOPED FOR USE ON, AND IN CONNECTION WITH, THE SPECIFIC PROJECT. NONE OF THESE IDEAS, PLANS, ARRANGEMENTS, AND SPECIFICATIONS SHALL BE USED BY OR DISCLOSED TO ANY PERSON, CORPORATION OR FIRM FOR ANY PURPOSE WHATSOEVER WITHOUT THE WRITTEN PERMISSION OF ADACHE GROUP ARCHITECTS. VISUAL CONTACT WITH THESE PLANS OR SPECIFICATIONS SHALL CONSTITUTE CONCLUSIVE EVIDENCE OF ACCEPTANCE OF THESE RESTRICTIONS. ALL RIGHTS RESERVED, © 2010
FLORIDA LICENSE # AR0007013

DATE:
SCALE:
DRAWN BY: JR
CHECKED BY: JB
JCB NO.: 94.08A

SHEET NO.:
R-1.03



NORTH ELEVATION RENDERING

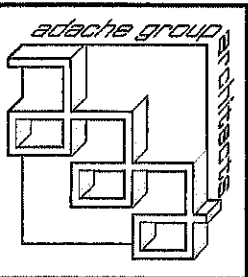

PROJECT DESIGN TEAM:
ARCHITECTS
ADACHE GROUP ARCHITECTS
3400 13TH STREET, SUITE 100
MIAMI, FLORIDA 33136
P: (305) 441-8800 F: (305) 441-8801
E: info@adachegroup.com
CREATIVE DESIGNER
PAT MCCORMICK CO.
11 BAKER PARKWAY
BROOKFIELD CENTER, VT. 05036
P: (802) 875-2000 F: (802) 875-2001
E: info@pccco.com
M.E.P. ENGINEER
TWR ENGINEERS
8700 S. DIAMOND BLVD.
MIAMI, FLORIDA 33156
P: (305) 441-8800 F: (305) 441-8801
E: info@twr-engineers.com
STRUCTURAL ENGINEER
TRC WORLDWIDE ENGINEERING
3000 N. W. 10TH STREET
FORT LAUDERDALE, FLORIDA 33309
P: (954) 461-1111 F: (954) 461-1112
CIVIL ENGINEER
CONSULTING ENGINEERING & SCIENCE, INC.
10100 KENNEL DRIVE, SUITE 400
MIAMI, FLORIDA 33156
P: (305) 576-5655 F: (305) 576-5656

OWNER:
MARGARITAVILLE HOLLYWOOD
BEACH RESORT, LLC
3601 N. OCEAN DRIVE
HOLLYWOOD, FLORIDA 33019



SEAL:

ISSUED FOR: TAC FINAL
DATE: 10/29/2010



REVISIONS:		
No.	DATE	REMARKS

SHEET TITLE:
EXTERIOR ELEVATION
RENDERING

ALL IDEAS, DESIGNS, ARRANGEMENTS, PLANS AND SPECIFICATIONS INDICATED OR REPRESENTED BY THIS DRAWING ARE OWNED BY, AND THE PROPERTY OF, ADACHE GROUP AND ARCHITECTS, INC. AND WERE CREATED, REVISED AND DEVELOPED FOR USE ON, AND IN CONNECTION WITH, THE SPECIFIC PROJECT. NONE OF THESE IDEAS, PLANS, ARRANGEMENTS, AND SPECIFICATIONS SHALL BE USED BY OR DISCLOSED TO ANY PERSON, ORGANIZATION OR FIRM FOR ANY PURPOSE WHATSOEVER WITHOUT THE WRITTEN PERMISSION OF ADACHE GROUP ARCHITECTS. VISUAL CONTACT WITH THESE PLANS OR SPECIFICATIONS SHALL CONSTITUTE CONCLUSIVE EVIDENCE OF ACCEPTANCE OF THESE REPRESENTATIONS. ALL RIGHTS RESERVED. © 2010
FLORIDA LICENSE # AR0007073

DATE:
SCALE:
DRAWN BY: JR
CHECKED BY: JB
JOB NO.: 84.08A

SHEET NO.:
R-1.04

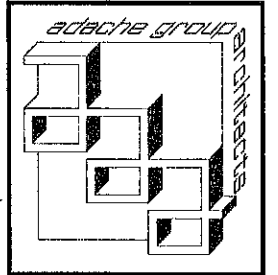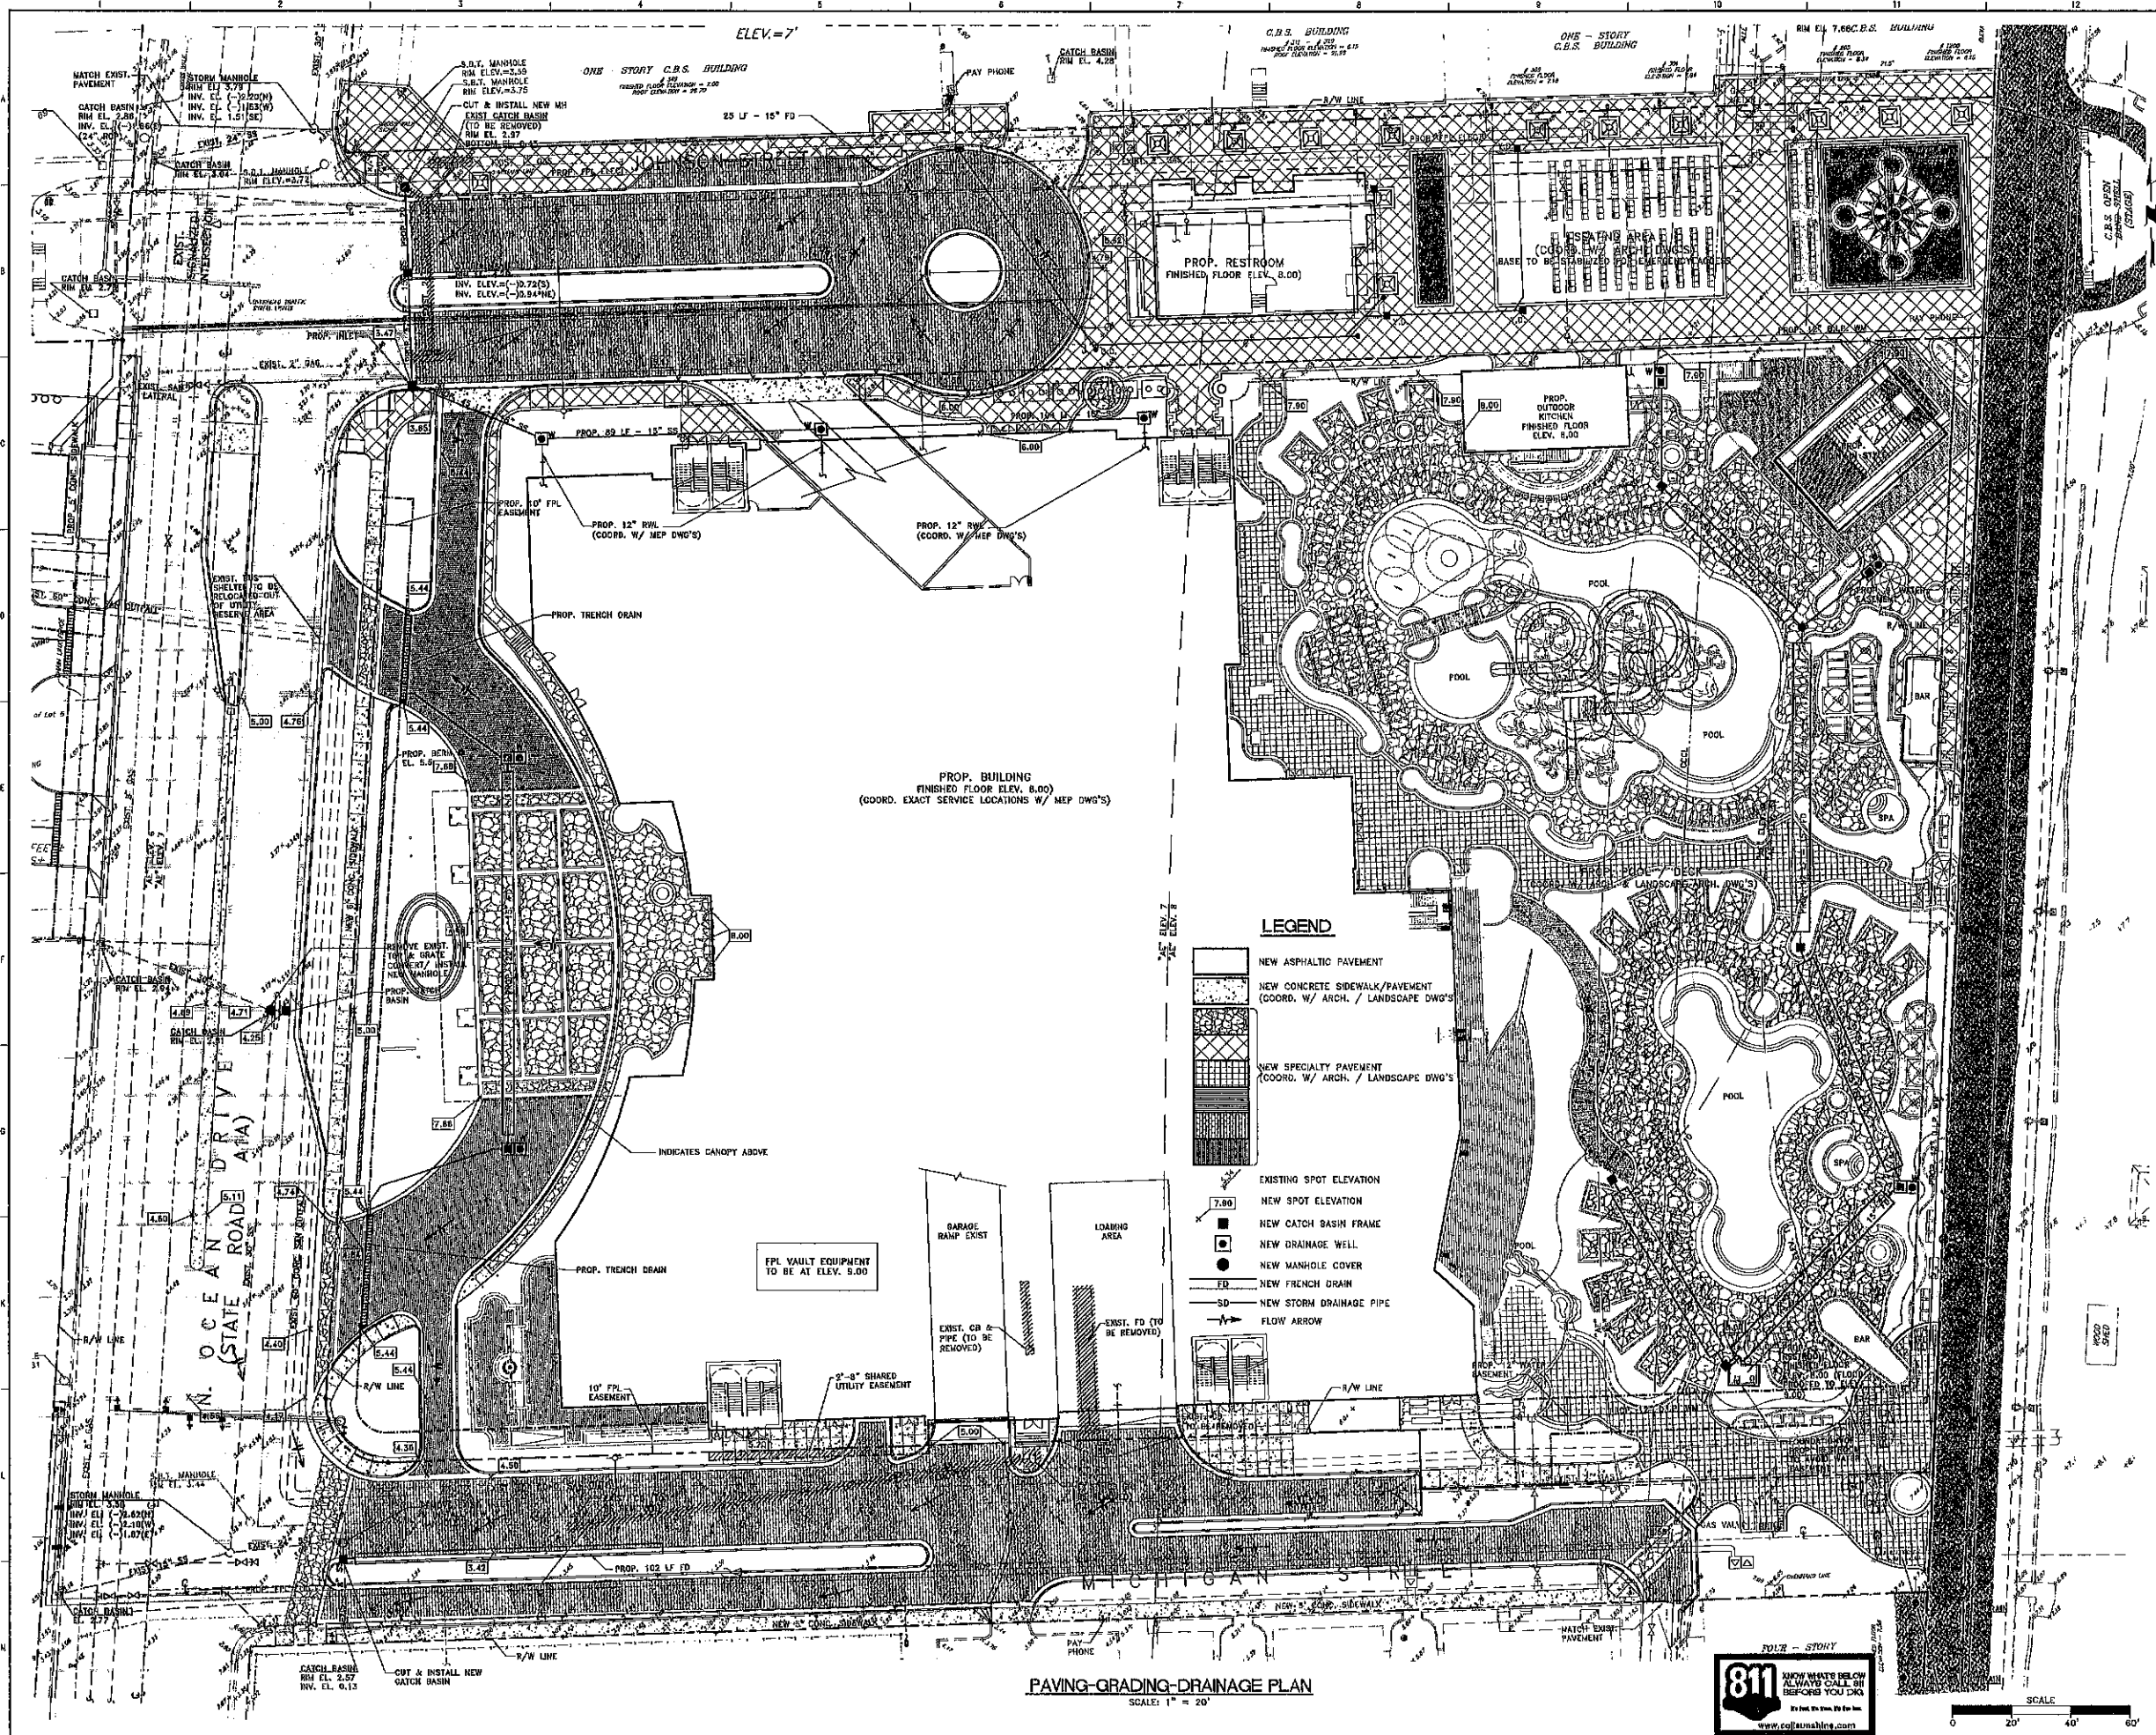

PROJECT DESIGN TEAM:
ARCHITECTS
ADACHI GROUP ARCHITECTS
500 SOUTH FEDERAL AVE. SUITE 100
LAUDERDALE, FLORIDA 33309
PHONE: (954) 337-1111 FAX: (954) 337-1119
E-MAIL: info@adachigrp.com
CREATIVE DESIGNER
PAT MCDONALD
11 BARRACLOUGH
MANHATTAN CENTER, VT. 05206
PHONE: (802) 888-1111 FAX: (802) 888-1119
E-MAIL: pat@adachigrp.com
M.E.P. ENGINEER
TWR ENGINEERS
2001 S. WILSON AVE. SUITE 100
MIAMI, FLORIDA 33156
PHONE: (305) 444-1111 FAX: (305) 444-1119
E-MAIL: twr@twr-engineers.com
STRUCTURAL ENGINEER
TRC WORLDWIDE ENGINEERING
2001 N.W. 86 STREET
FORT LAUDERDALE, FLORIDA 33309
PHONE: (954) 484-7711 FAX: (954) 484-7824
CIVIL ENGINEER
CONSULTING ENGINEERING & SCIENCE, INC.
1000 KENNEDY DRIVE, SUITE 400
MIAMI, FLORIDA 33137
PHONE: (305) 578-0555 FAX: (305) 278-4555

OWNER: MARGARITAVILLE HOLLYWOOD
BEACH RESORT, LLC
3501 N. OCEAN DRIVE
HOLLYWOOD, FLORIDA 33019



SEAL:
CONSULTING ENGINEERING & SCIENCE, INC.
1000 KENNEDY DRIVE, SUITE 400
MIAMI, FLORIDA 33137
E-0002215 (09/03/2010)
FOR THE PROJECT: 09060
BY: S.D. (09/03/2010)

ISSUED FOR: TAC PROGRESS
DATE: 10/27/2010

REVISIONS:		
No.	DATE	REMARKS

SHEET TITLE:
PAVING-GRADING-DRAINAGE PLAN


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FLORIDA LICENSE # A00007073

DATE: 09/03/2010
SCALE: AS SHOWN
DRAWN BY: S.D.
CHECKED BY: B.P.
JOB NO.: 09060

SHEET NO.: C-4



PAVING-GRADING-DRAINAGE PLAN
SCALE: 1" = 20'

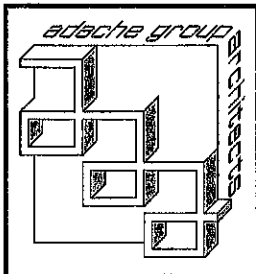

PROJECT DESIGN TEAM:
ARCHITECTS
ADACHE GROUP ARCHITECTS
500 SOUTH FEDERAL HIGHWAY, 11TH FLOOR
MIAMI, FLORIDA 33130
PHONE: 305.372.1100 FAX: 305.372.1101
E-MAIL: info@adachegroup.com
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PAT MCBRIDE CO.
11000 SW 15TH AVE.
MIAMI, FLORIDA 33158
PHONE: 305.372.1100 FAX: 305.372.1101
E-MAIL: pat@adachegroup.com
M.E.P. ENGINEER
TWR ENGINEERS
3200 N. DIAMOND BLVD.
APT. 1000, MIAMI, FLORIDA 33135
PHONE: 305.372.1100 FAX: 305.372.1101
E-MAIL: twr@adachegroup.com
STRUCTURAL ENGINEER
TRC WORLDWIDE ENGINEERING
3300 NW 36TH STREET
FORT LAUDERDALE, FLORIDA 33309
PHONE: 954.777.7777 FAX: 954.777.7778
CIVIL ENGINEER
CONSULTING ENGINEERING & SCIENCE, INC.
10000 N. DIAMOND BLVD., SUITE 400
MIAMI, FLORIDA 33158
PHONE: 305.372.1100 FAX: 305.372.1101

OWNER:
MARGARITAVILLE HOLLYWOOD
BEACH RESORT, LLC
3501 N. OCEAN DRIVE
HOLLYWOOD, FLORIDA 33019



SEAL:

ISSUED FOR: TAC REVIEW
DATE: 9/03/2010


REVISIONS:		
No.	DATE	REMARKS



SHEET TITLE:
LANDSCAPE
SITE PLAN

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FLORIDA LICENSE # AR0207073

DATE: 9/03/2010
SCALE: 1" = 30'-0"
DRAWN BY: MM
CHECKED BY: DA
JOB NO.: 10046

SHEET NO.:
L1.00

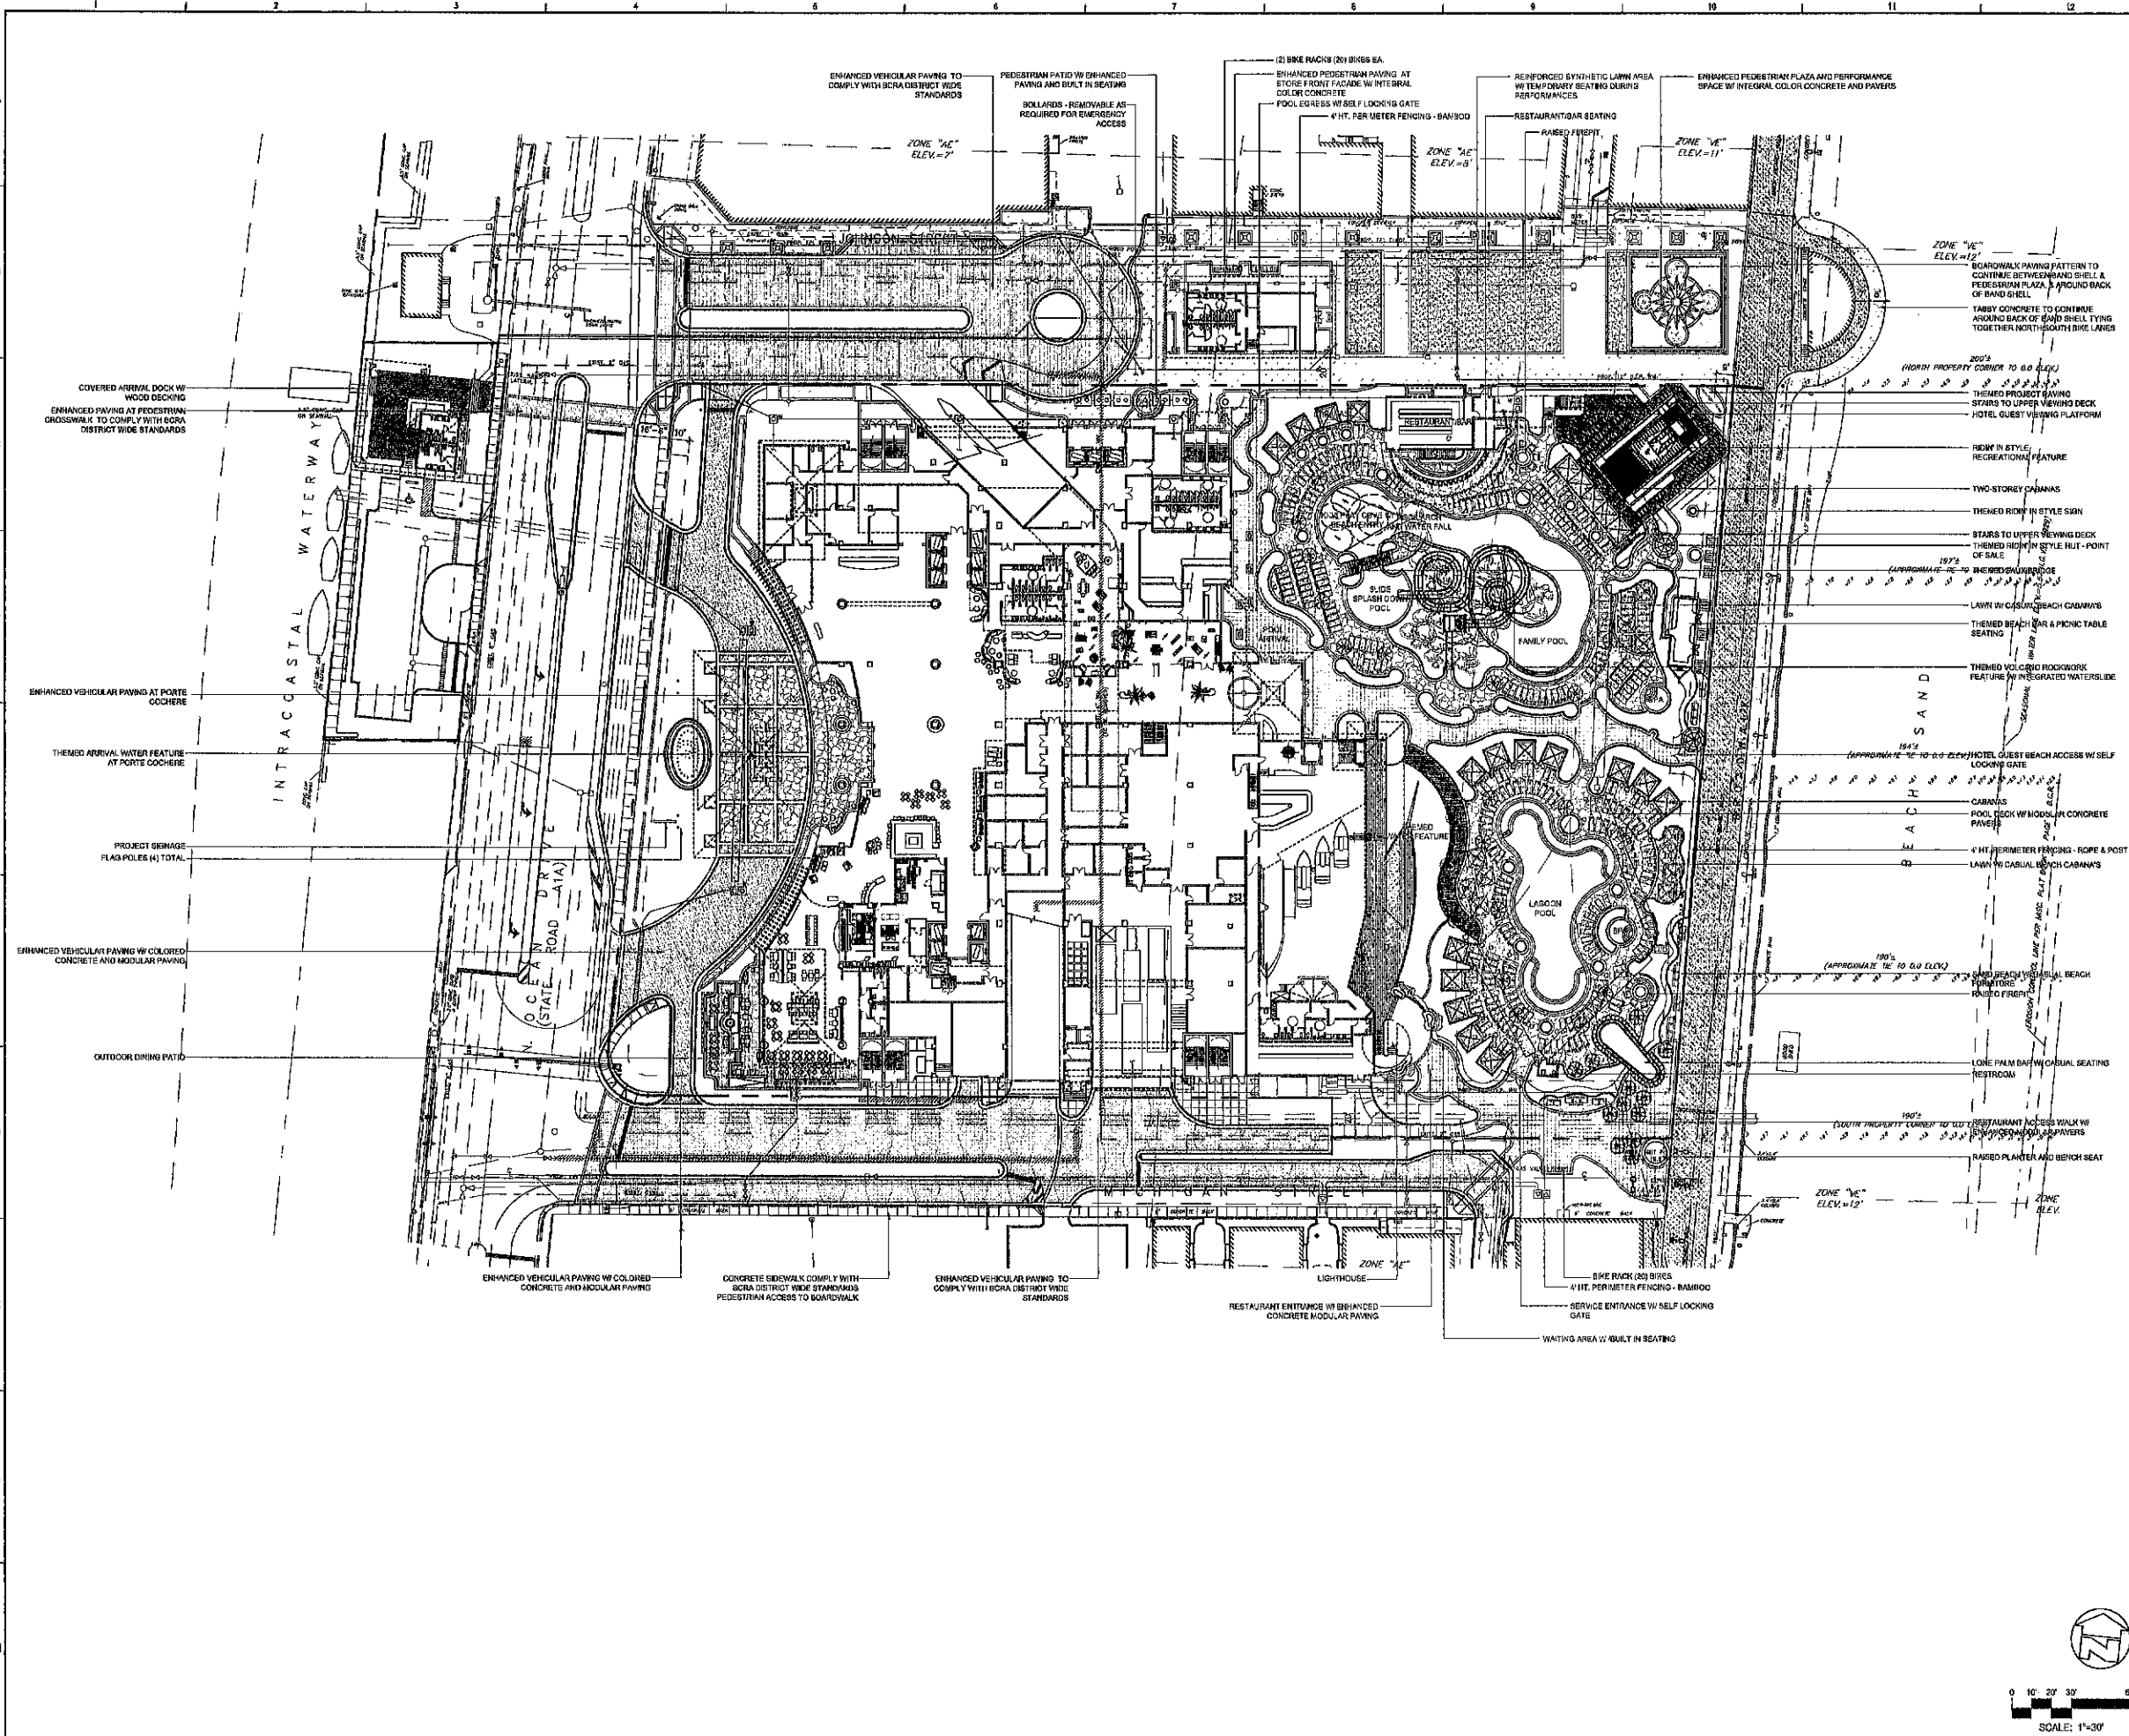

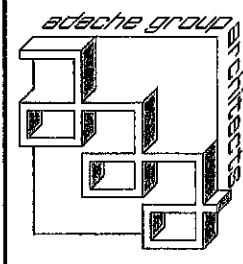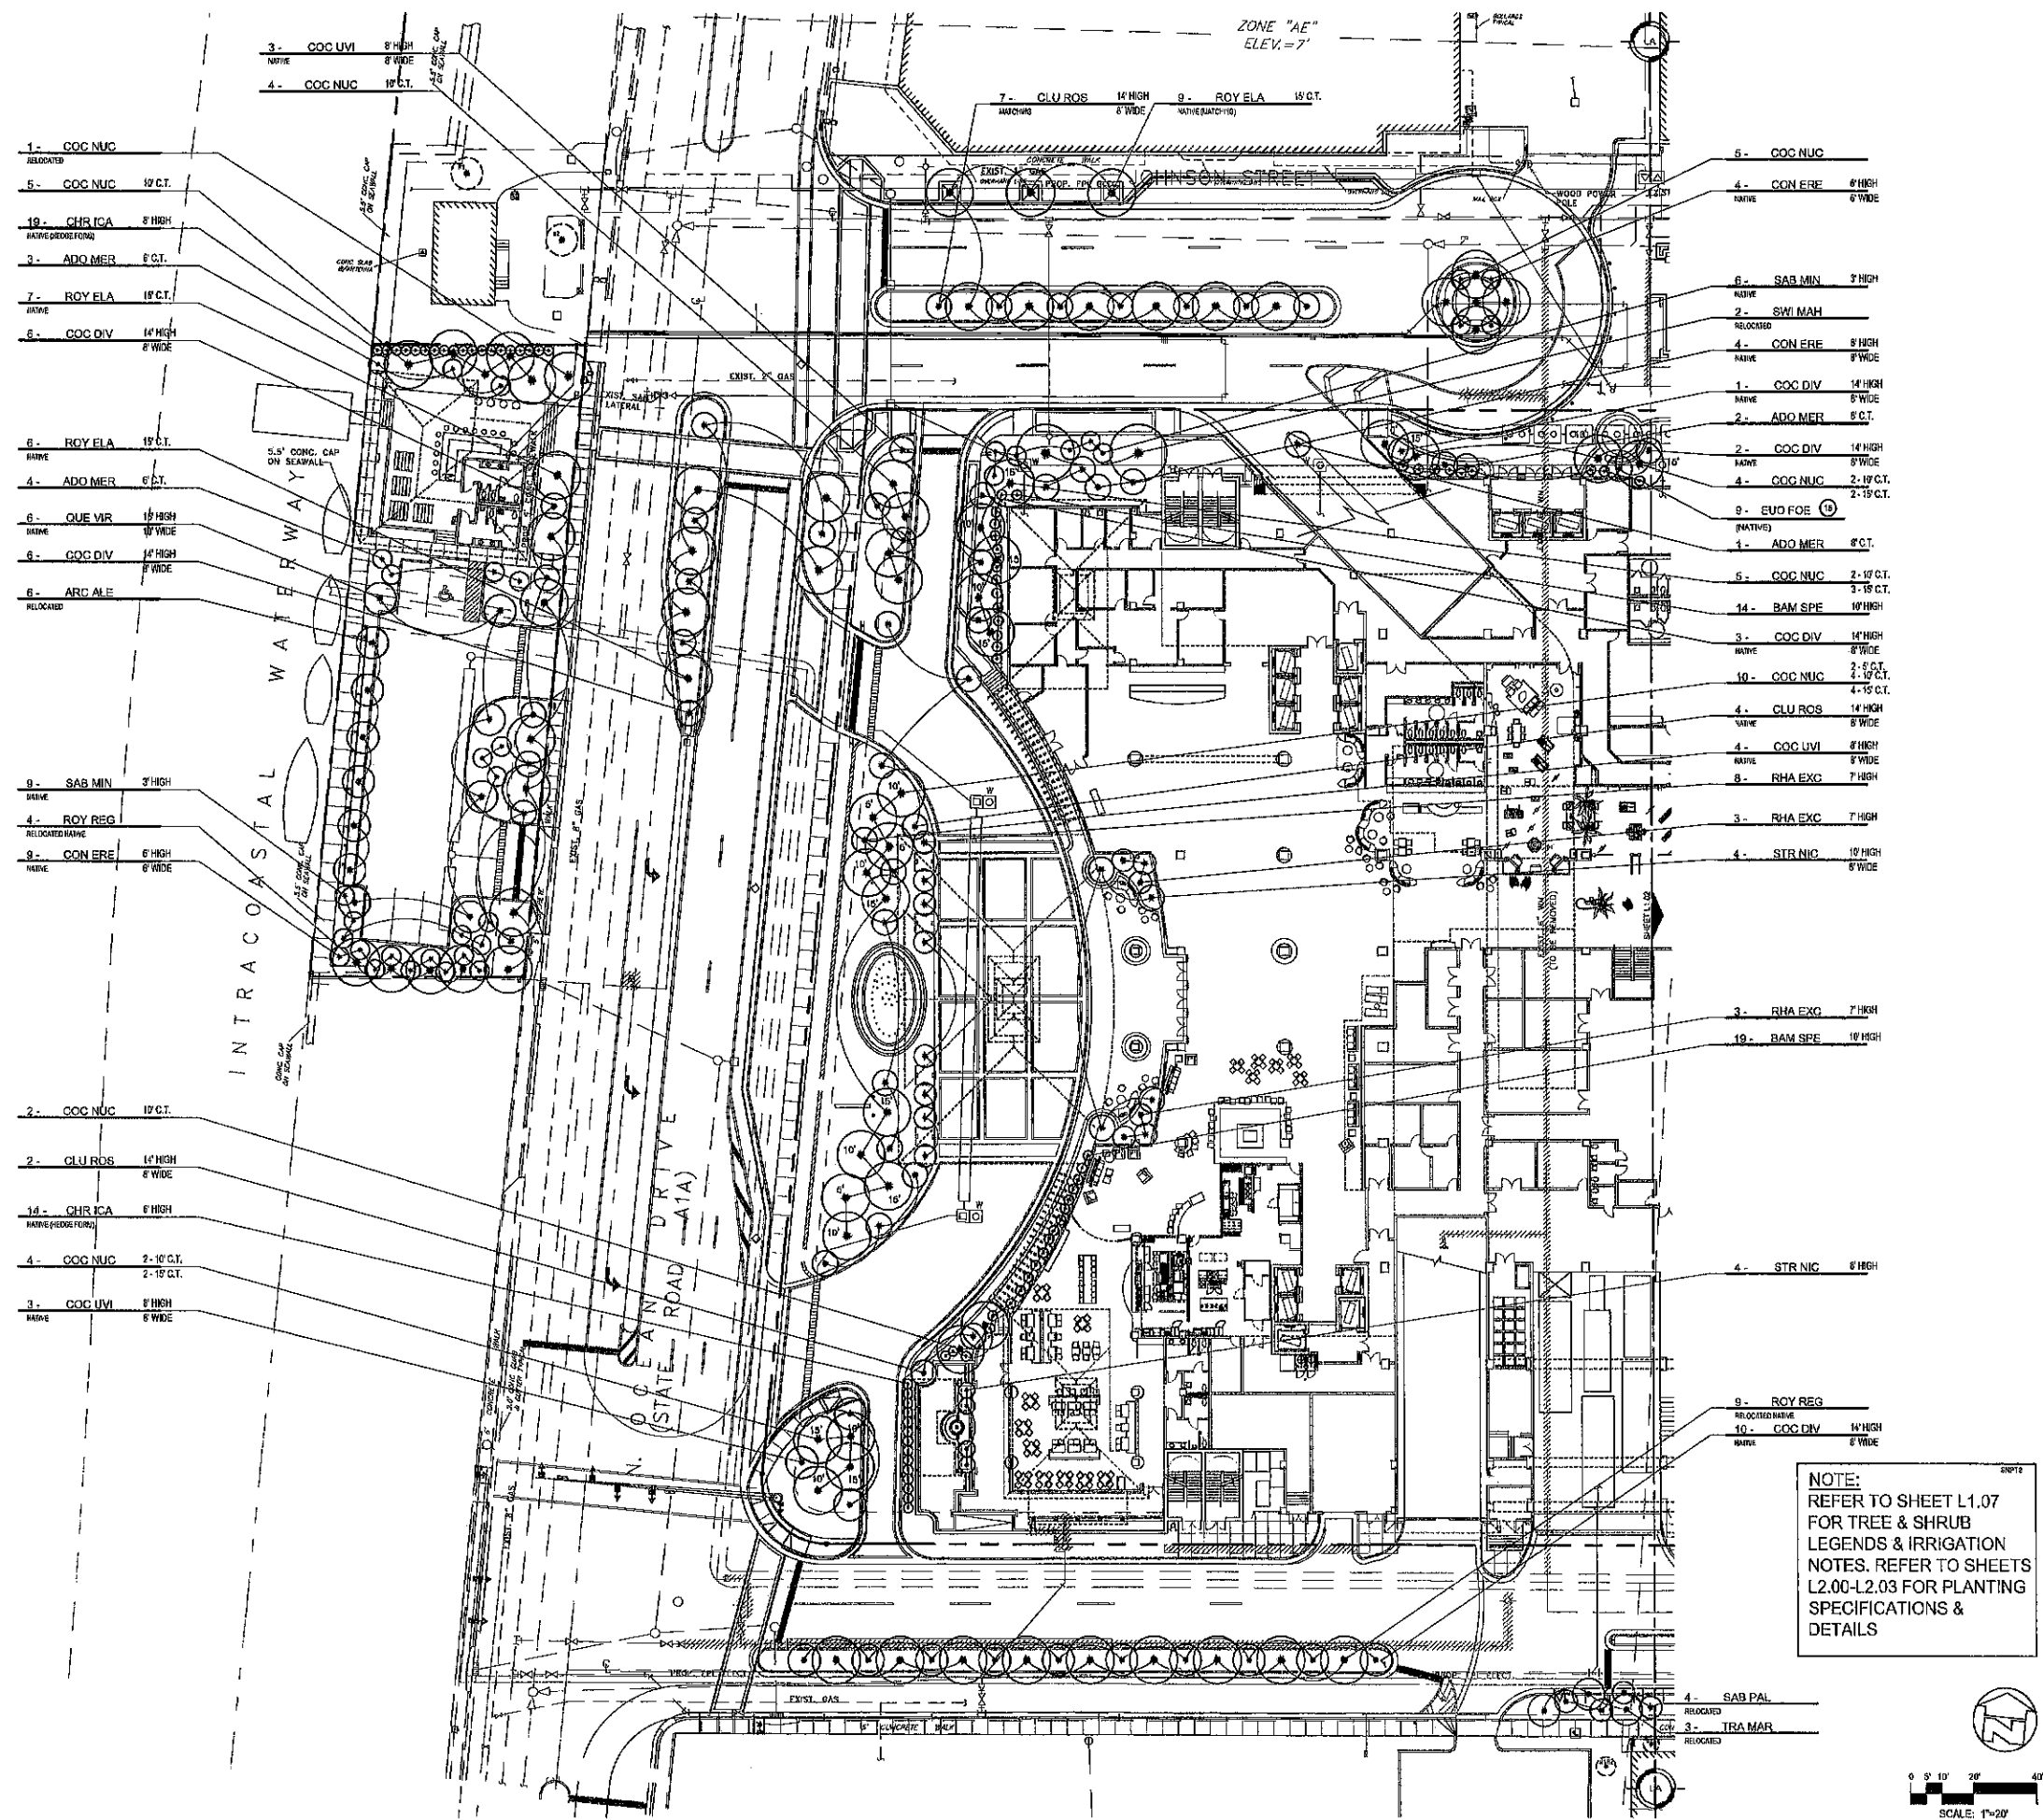

PROJECT DESIGN TEAM:
ARCHITECTS
ADAGIAC GROUP ARCHITECTS
150 SOUTH FEDERAL HIGHWAY FT.
HENDERSON, FLORIDA 33501
TEL: (615) 222-1233 FAX: (615) 222-4156
E-MAIL: info@adagiac.com

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PAT MCBRIDE CO.
11000 N. HAWK FARM RD.
MANHATTEN CENTURY, NY 10863
TEL: (718) 231-6234 FAX: (718) 231-4700
E-MAIL: info@mcbride-design.com

M.E.P. ENGINEER
TWR ENGINEERS
6100 S. DARLINGTON BLVD
MIAMI, FLORIDA 33156
TEL: (305) 426-0625 FAX: (305) 676-0830
E-MAIL: info@twr-engineers.com

STRUCTURAL ENGINEER
TRC WORLDWIDE ENGINEERING
3004 NW 15 ST ORLANDO
FORT LAUDERDALE, FLORIDA 33309
TEL: (954) 277-4444 FAX: (954) 264-7353

CIVIL ENGINEER
CONSULTING ENGINEERING & SCIENCE, INC.
16750 KENDALL DRIVE, SUITE 400
MIAMI, FLORIDA 33176
(305) 378-5555 FAX: (305) 279-5573

OWNER: MARGARITAVILLE HOLLYWOOD
BEACH RESORT, LLC.
3501 N. OCEAN DRIVE
HOLLYWOOD, FLORIDA 33019



SEAL:

ISSUED FOR: TAC REVIEW
DATE: 9/03/2010

REVISIONS:

[illegible]

SHEET TITLE:
LANDSCAPE
PLANTING PLAN - TREES


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FLORIDA LICENSE # AR0007673



DATE: 9/03/2010
SCALE: 1" = 20'-0"
DRAWN BY: MM
CHECKED BY: DA
JOB NO.: 10046

SHEET NO.:

L1.01

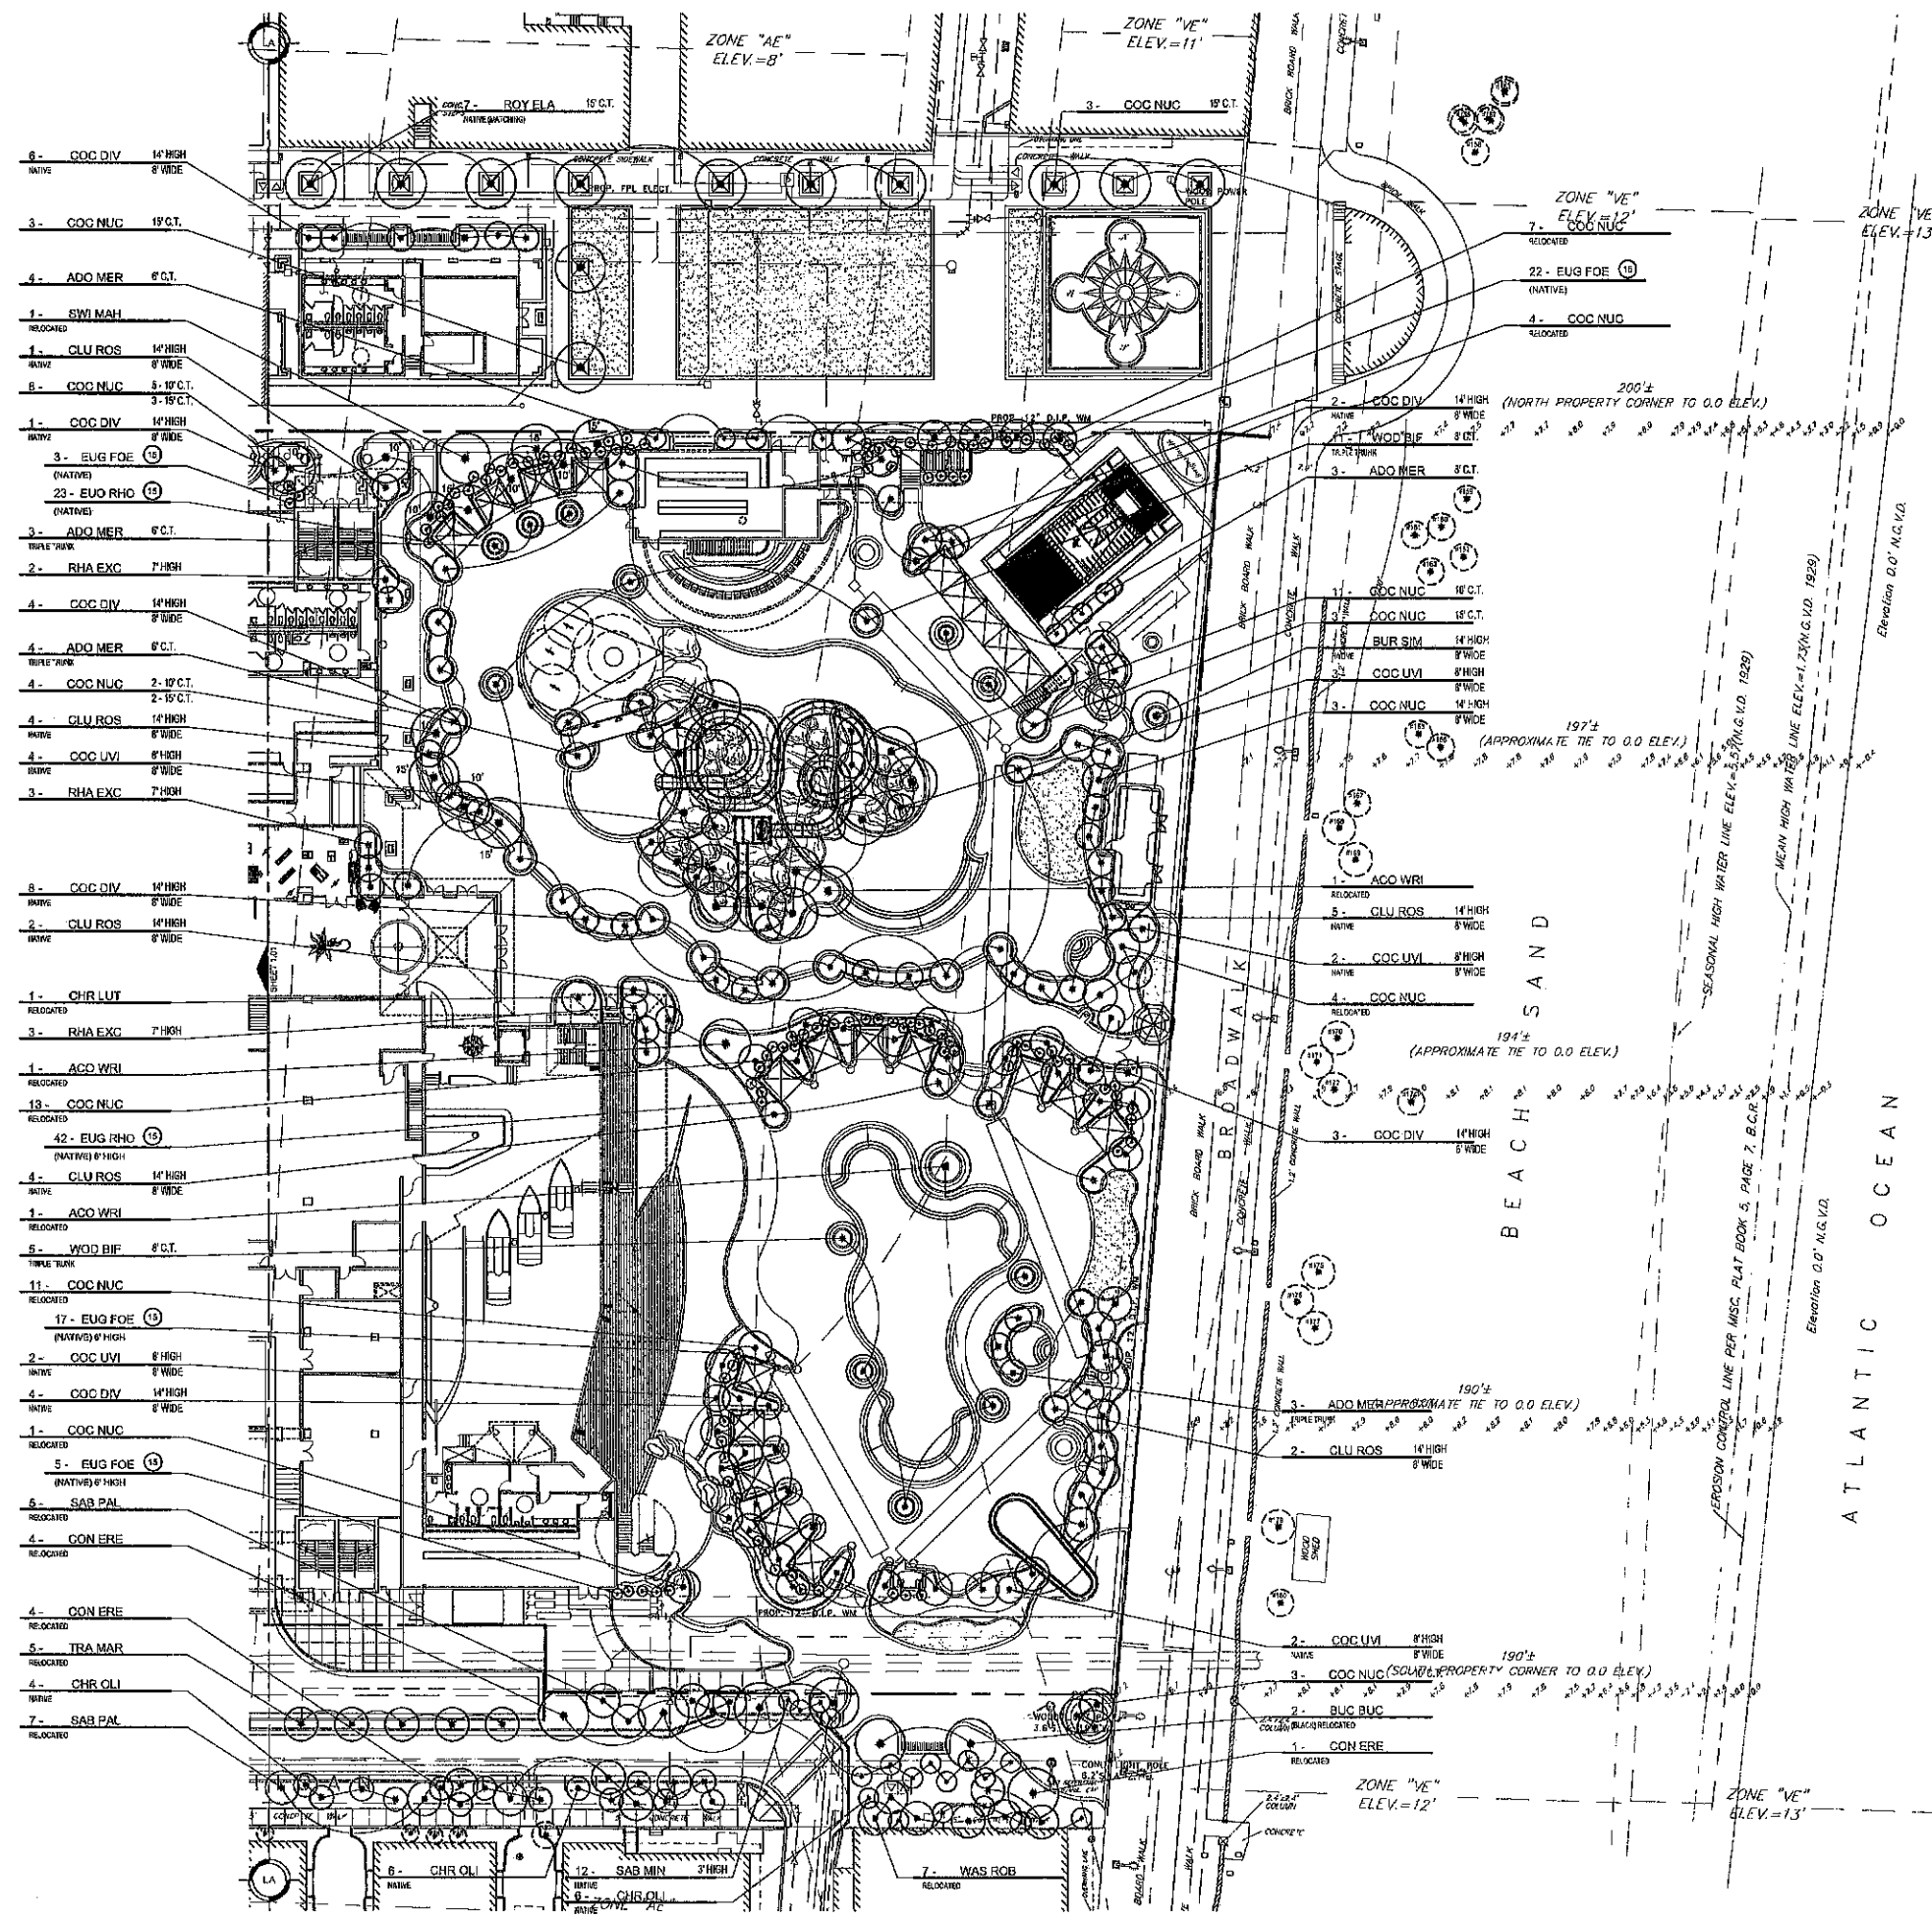

NOTE:
REFER TO SHEET L1.07
FOR TREE & SHRUB
LEGENDS & IRRIGATION
NOTES. REFER TO SHEETS
L2.00-L2.03 FOR PLANTING
SPECIFICATIONS &
DETAILS

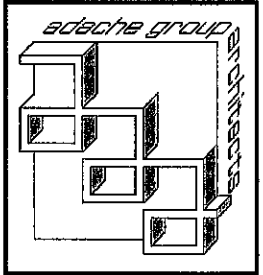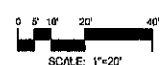

PROJECT DESIGN TEAM:
ARCHITECTS
ADACHE GROUP ARCHITECTS
500 SOUTH FEDERAL AVENUE, SUITE 100
LAUDERHILL, FLORIDA 33309
PHONE: 954-333-1111 FAX: 954-333-1112
EMAIL: info@adachegroup.com
CREATIVE DESIGNER
PAT MCHENRY CO.
11 BAKER FARM RD.
MARGHERITA CENTER, VT. 05255
PHONE: 802-222-1111 FAX: 802-222-1112
EMAIL: pat@patmcherry.com
M.E.P. ENGINEER
TWR ENGINEERS
1000 E. CHAMPLAIN BLVD.
APT. 100, FLORIDA 33408
PHONE: 813-942-1111 FAX: 813-942-1112
EMAIL: info@twr.com
STRUCTURAL ENGINEER
TRC WORLDWIDE ENGINEERING
3000 W. 13TH STREET
FORT LAUDERDALE, FLORIDA 33305
PHONE: 954-777-1111 FAX: 954-777-1112
CIVIL ENGINEER
CONSULTING ENGINEERING & SCIENCE, INC.
1000 KENDALL DRIVE, SUITE 400
MIAMI, FLORIDA 33135
PHONE: 305-435-1111 FAX: 305-435-1112

OWNER: MARGARITAVILLE HOLLYWOOD
BEACH RESORT, L.L.C.
3501 N. OCEAN DRIVE
HOLLYWOOD, FLORIDA 33019



SEAL:

ISSUED FOR: TAC REVIEW
DATE: 9/03/2010


REVISIONS:		
No.	DATE	REMARKS

SHEET TITLE:
LANDSCAPE
PLANTING PLAN - TREES

ALL IDEAS, DESIGNS, ARRANGEMENTS, PLANS AND SPECIFICATIONS INDICATED OR REPRESENTED BY THIS DRAWING ARE OWNED BY, AND THE PROPERTY OF, ADACHE GROUP ARCHITECTS, INC. AND WERE CREATED, DEVELOPED AND DESIGNED FOR USE ON, AND IN CONNECTION WITH, THE SPECIFIED PROJECT. NONE OF THESE IDEAS, PLANS, ARRANGEMENTS, AND SPECIFICATIONS SHALL BE USED BY OR DISCLOSED TO ANY PERSON, CORPORATION OR FIRM FOR ANY PURPOSE WHATSOEVER WITHOUT THE WRITTEN PERMISSION OF ADACHE GROUP ARCHITECTS. VISUAL CONTACT WITH THESE PLANS OR SPECIFICATIONS SHALL CONSTITUTE CONCLUSIVE EVIDENCE OF ACCEPTANCE OF THESE RESTRICTIONS. ALL RIGHTS RESERVED. © 2010
FLORIDA LICENSE # ARB007073

DATE: 9/03/2010
SCALE: 1" = 20'-0"
DRAWN BY: MM
CHECKED BY: DA
JOB NO.: 10046

SHEET NO.:
L1.02

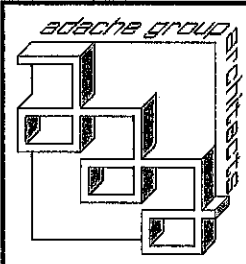

PROJECT DESIGN TEAM:
ARCHITECTS
ADACHE GROUP ARCHITECTS
550 SOUTH FEDERAL HIGHWAY FT.
LAUDERDALE, FLORIDA 33301
PH: (954) 538-8113 FAX: (954) 538-8119
E-MAIL: info@adache.com

CREATIVE DESIGNER
PAT MCGURKE CO.
11 SUGGS ROAD
MANCHESTER CENTER, VT. 05255
PH: (802) 878-0329 FAX: (802) 878-0329
E-MAIL: pat@mcgurke.com

M.E.P. ENGINEER
TWR ENGINEERS
6000 S. OCEAN BLVD. SUITE 400
MIAMI, FLORIDA 33149
PH: (305) 550-0855 FAX: (305) 550-0855
E-MAIL: twr@twr.com

STRUCTURAL ENGINEER
TRC WORLDWIDE ENGINEERING
3800 NW 36 STREET
FORT LAUDERDALE, FLORIDA 33309
(954) 484-7777 FAX: (954) 484-7834

CIVIL ENGINEER
CONSULTING ENGINEERING & SCIENCE, INC.
1600 KENDALL DRIVE, SUITE 400
MIAMI, FLORIDA 33149
(305) 378-5555 FAX: (305) 378-4503

OWNER:
MARGARITAVILLE HOLLYWOOD
BEACH RESORT, LLC
3501 N. OCEAN DRIVE
HOLLYWOOD, FLORIDA 33019



SEAL:

ISSUED FOR: TAC REVIEW
DATE: 9/03/2010


REVISIONS:		
No.	DATE	REMARKS

SHEET TITLE:
LANDSCAPE
PLANTING PLAN - SHRUBS


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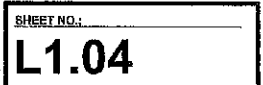
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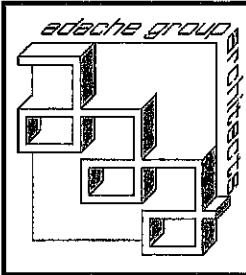
SHEET NO.:
L1.03



NOTE:
REFER TO SHEET L1.07
FOR TREE & SHRUB
LEGENDS & IRRIGATION
NOTES, REFER TO SHEETS
L2.00-L2.03 FOR PLANTING
SPECIFICATIONS &
DETAILS

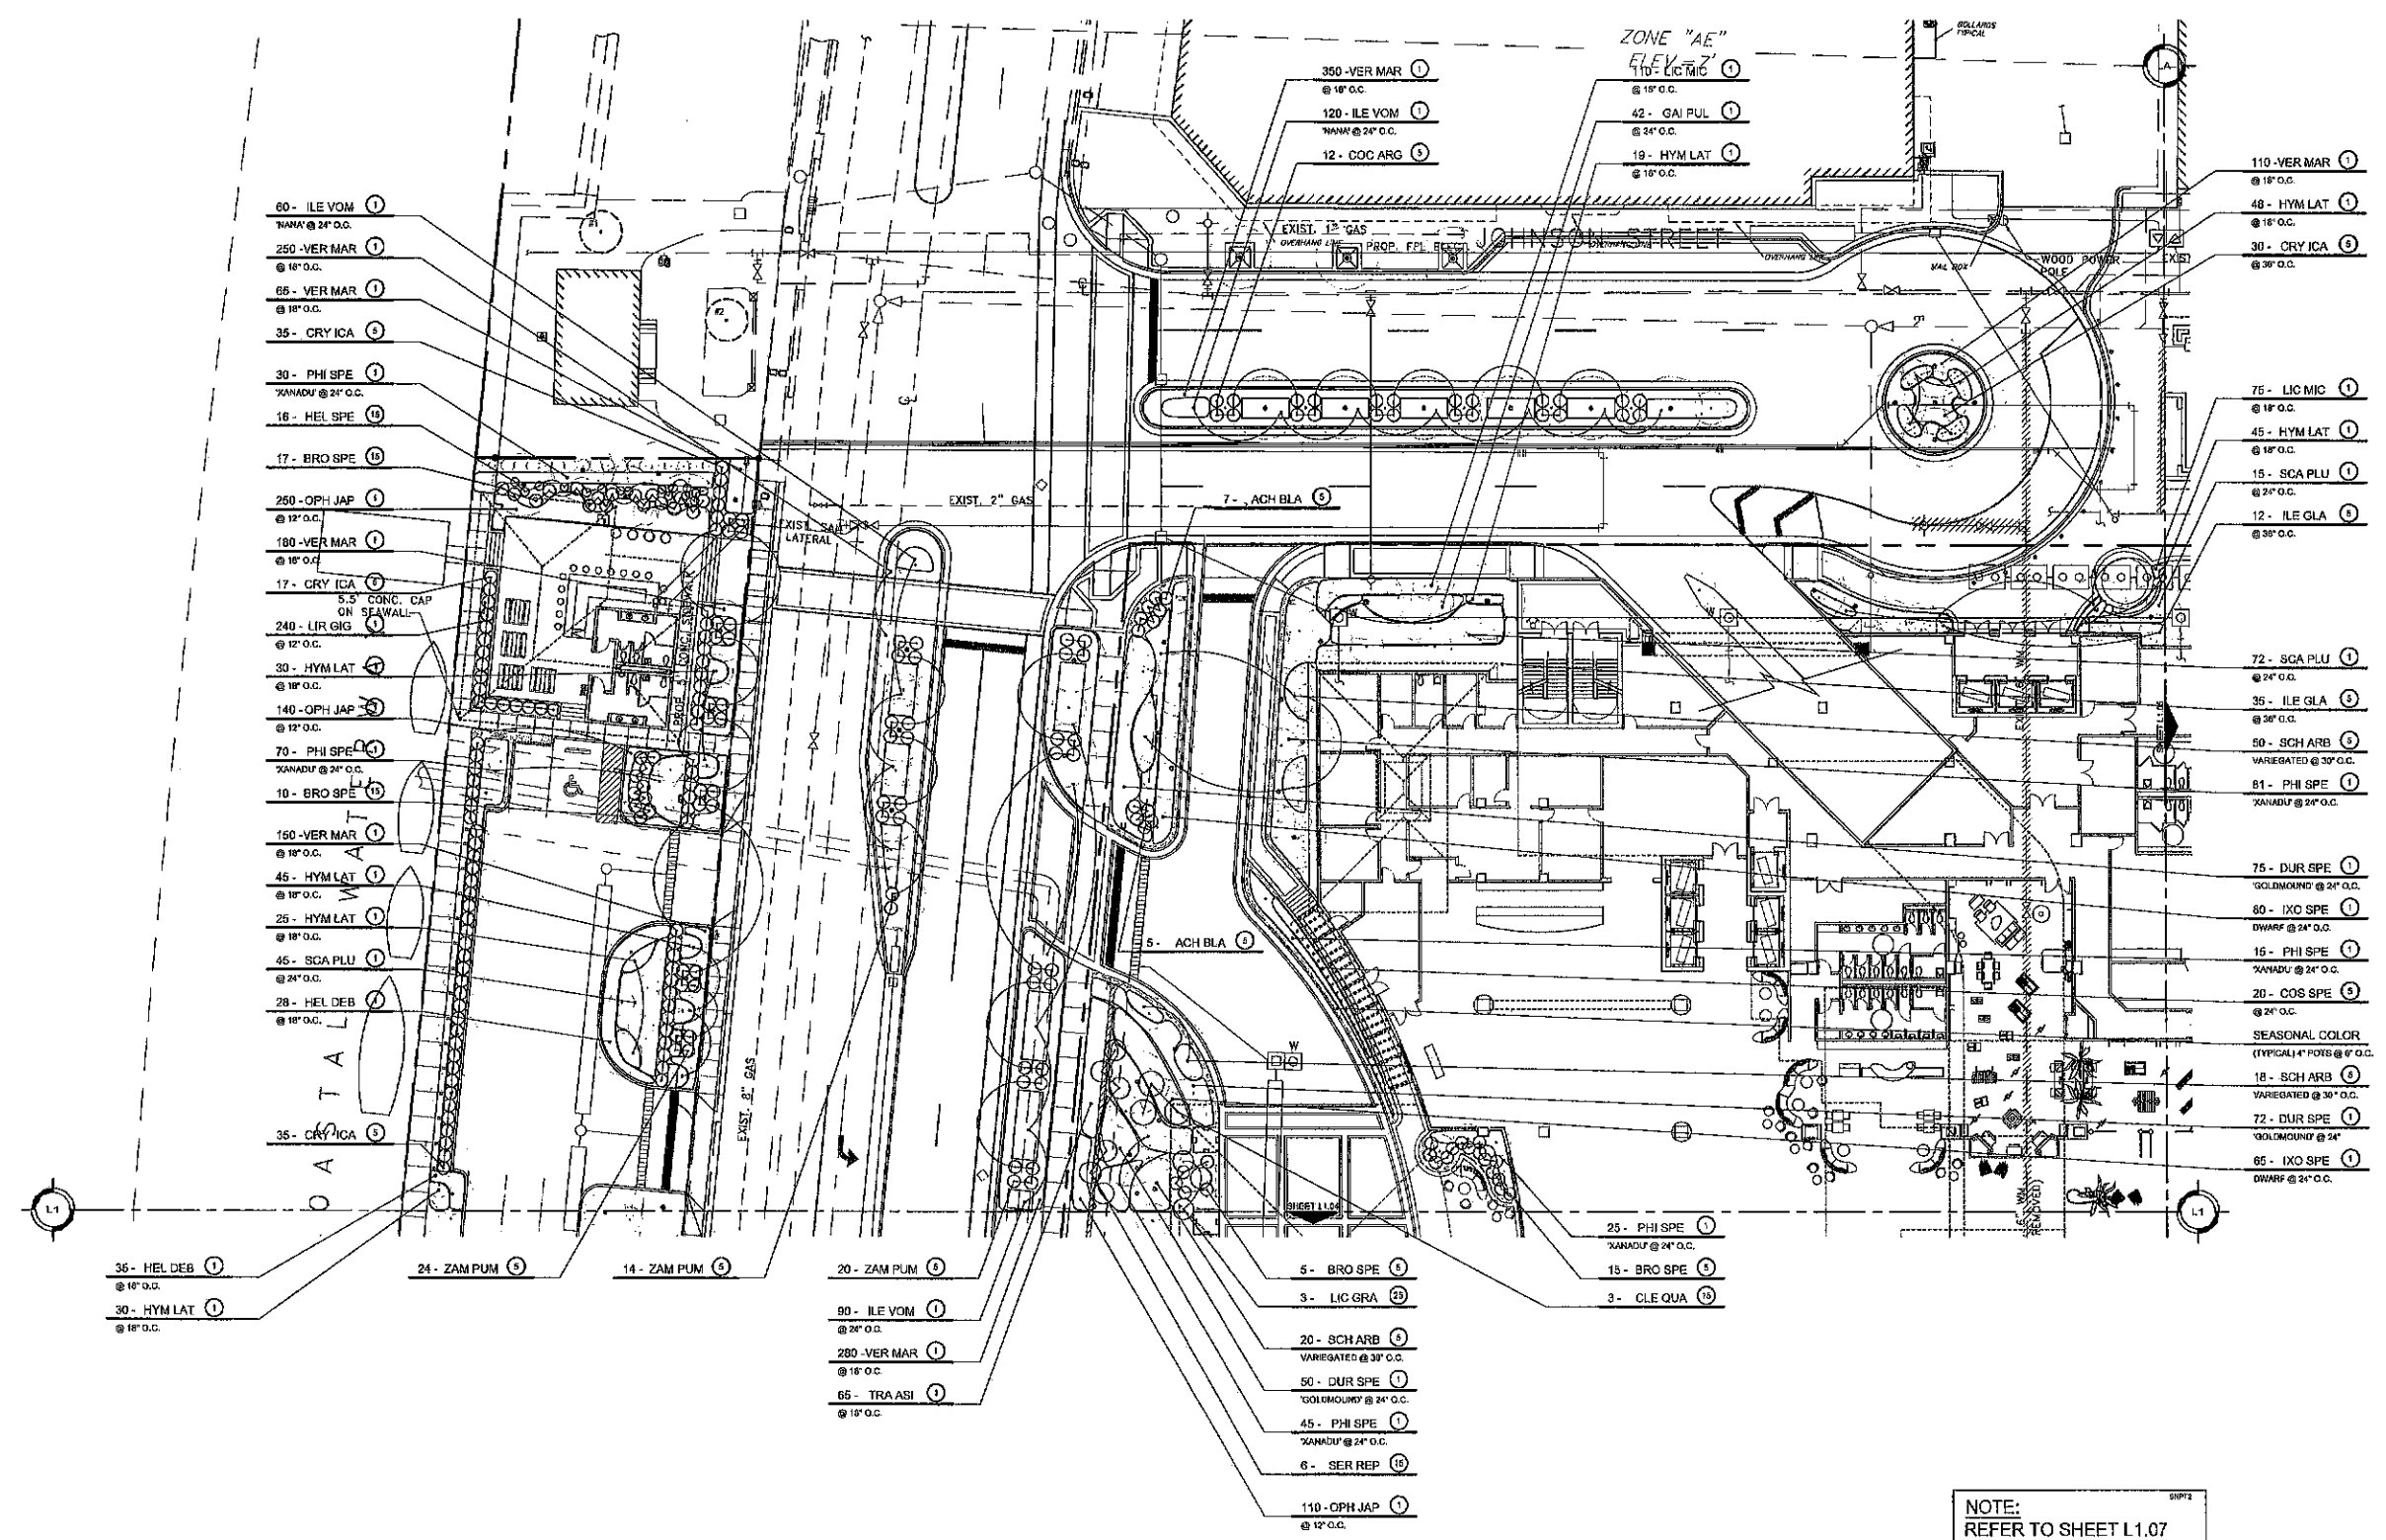



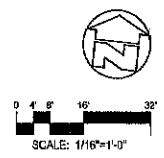

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BEACH RESORT, LLC.
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SEAL:

ISSUED FOR: TAC REVIEW
DATE: 9/03/2010


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SHEET TITLE:
LANDSCAPE
PLANTING PLAN - SHRUBS


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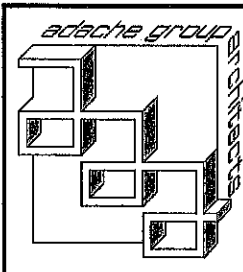
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SHEET NO.:
L1.05



NOTE:
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NOTES. REFER TO SHEETS
L2.00-L2.03 FOR PLANTING
SPECIFICATIONS &
DETAILS



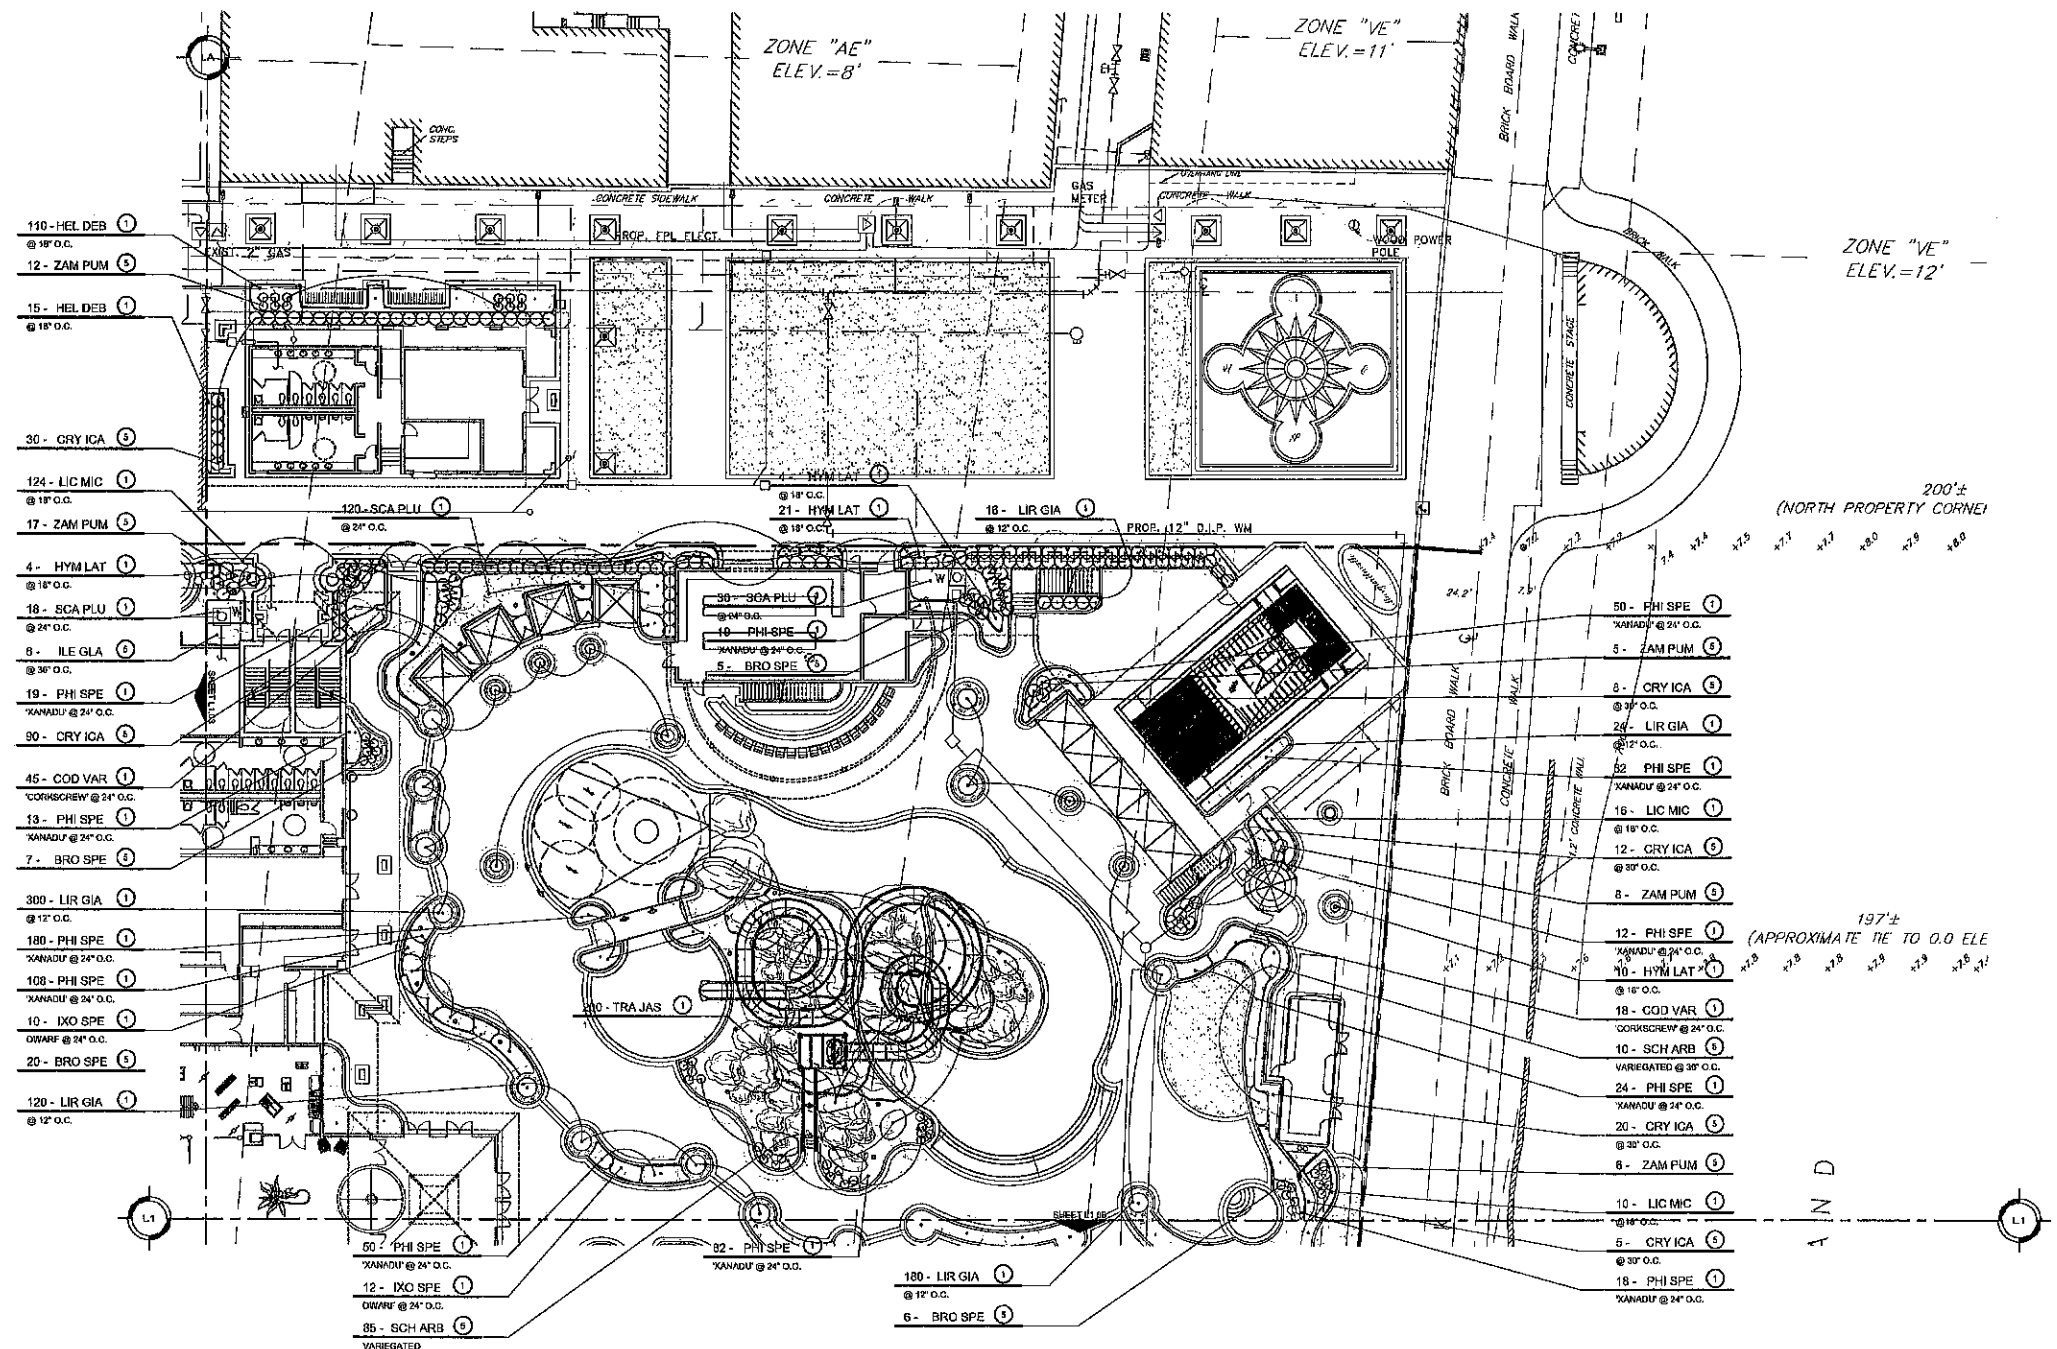
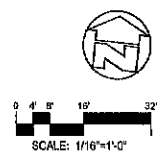
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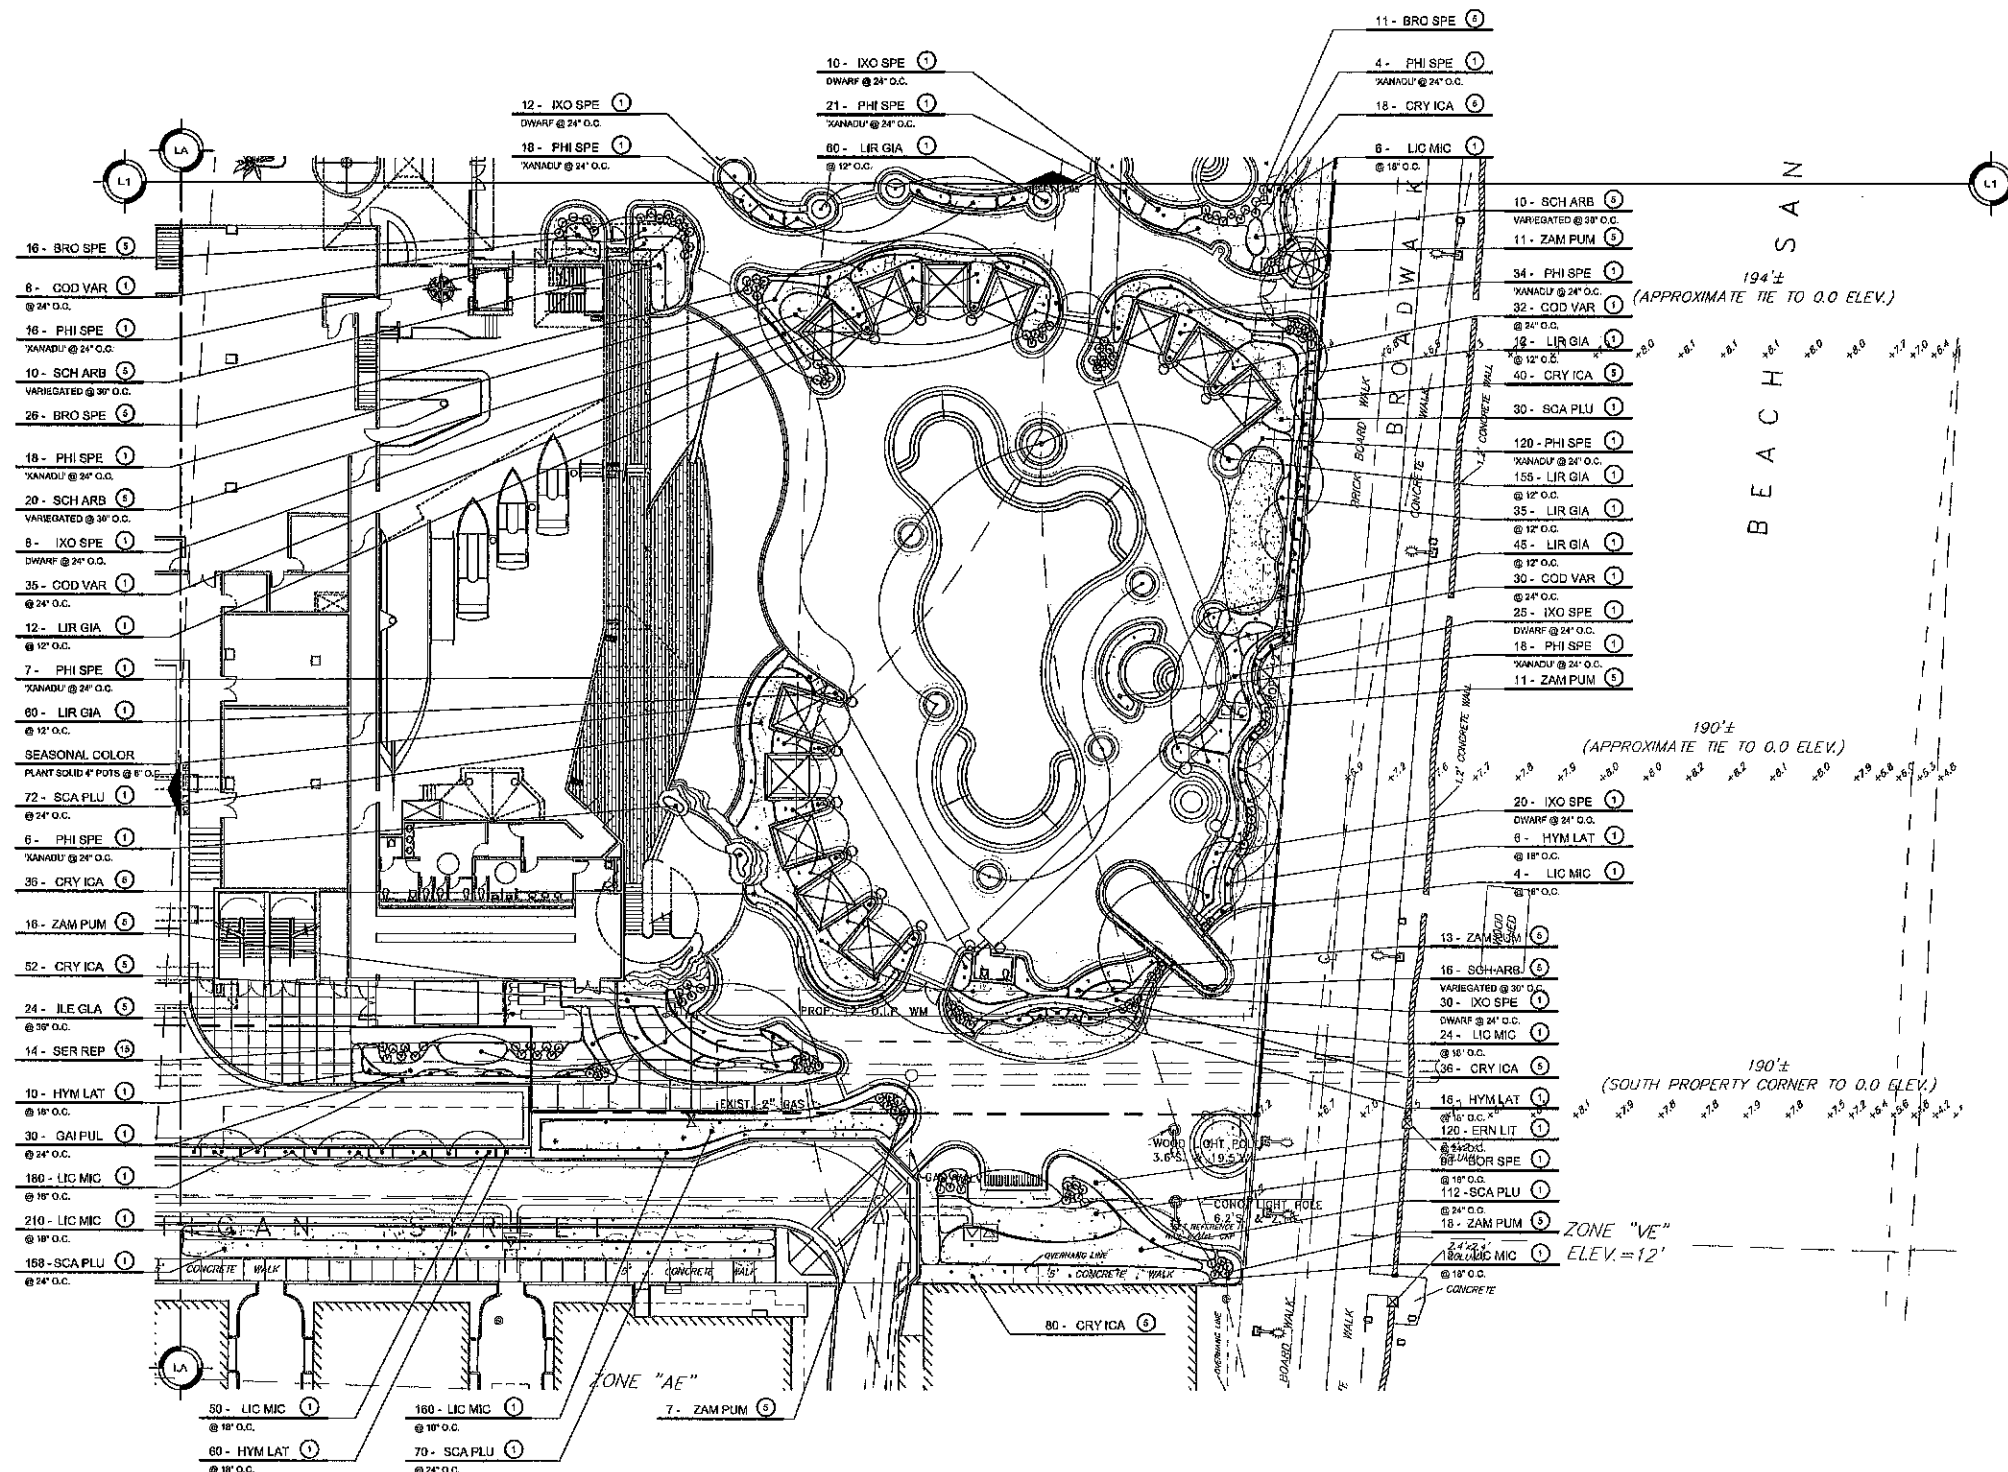
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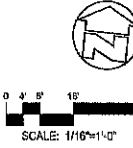
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SHEET NO.:
L1.06



NOTE:
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FOR TREE & SHRUB
LEGENDS & IRRIGATION
NOTES. REFER TO SHEETS
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SPECIFICATIONS &
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LANDSCAPE PLANTING

PART 1: GENERAL

1.01 WORK COVERED:

THE WORK UNDER THIS SECTION SHALL INCLUDE ALL LABOR, MATERIALS, AND EQUIPMENT REQUIRED TO COMPLETE ALL LANDSCAPE WORK AS INDICATED ON THE DRAWINGS AND AS SPECIFIED HEREIN. WORK INCLUDES, BUT IS NOT LIMITED TO, THE FOLLOWING:

- FINE GRADING OF ALL PLANTING AREAS.
- SOIL PREPARATION AND FERTILIZATION.
- FURNISHING AND INSTALLING TREES AND PALMS.
- FURNISHING AND INSTALLING SHRUBS AND GROUND COVER.
- FURNISHING AND INSTALLING POTTERY AND SPECIALTY PLANTS IN POTS.
- STAKING OR GUYING OF TREES.
- PROTECTION, MAINTENANCE AND GUARANTEE AS SPECIFIED.
- ALL WORK OF EVERY DESCRIPTION MENTIONED IN THE SPECIFICATIONS AND AMENDMENTS THERETO, AND ALL OTHER SATISFACTORY COMPLETION OF THE WORK AS DETERMINED BY THE OWNER INCLUDING CLEAN UP OF THE SITE.
- CONTRACTOR AND OTHER SUB-CONTRACTORS AS REQUIRED TO PROPERLY COMPLETE THE WORK.

1.02 PREPARATION AND SUBMITTAL OF CONSTRUCTION SCHEDULES AND PLANT MATERIAL DELIVERY SCHEDULES TO COMPLETE WORK ACCORDING TO THE GENERAL CONTRACTOR'S COMPLETION SCHEDULE.

1.03 RELATED WORK IN OTHER SECTIONS

- ANALYSIS OF IMPORTED TOP SOIL AND ORGANIC SOIL AMENDMENTS IS REQUIRED PRIOR TO SHIPPING AND SHALL BE PERFORMED BY A QUALIFIED SOIL LAB AND THE RESULTS GIVEN TO THE LANDSCAPE ARCHITECT FOR APPROVAL.
- THE OWNER MAY ORDER FERTILITY TESTS OF SOIL PREPARATION AREAS, PREPARED BACKFILL MIX AREAS, AND IMPORT SOIL AREAS AFTER COMPLETION OF PLANTING TO ASSURE ALL SPECIFIED AMENDMENTS HAVE BEEN PROVIDED. TESTS SHALL BE PERFORMED BY A QUALIFIED SOIL LAB. (THE COST OF SOIL TESTS THAT FAIL SHALL BE BORNE BY THE LANDSCAPE CONTRACTOR).
- SAMPLES OF ALL MATERIALS SHALL BE SUBMITTED TO THE LANDSCAPE ARCHITECT FOR REVIEW AND APPROVAL. DELIVERY MAY BEGIN UPON APPROVAL OF SAMPLES. SAMPLES SHALL INCLUDE BUT NOT BE LIMITED TO FERTILIZERS AND SOIL AMENDMENTS, PLANT MATERIAL AND ANY OTHER MATERIALS INDICATED HEREIN.
- CERTIFICATES: THE LANDSCAPE CONTRACTOR SHALL FURNISH A CERTIFICATE OF DELIVERY SLIP WITH EACH DELIVERY OF MATERIAL IN CONTAINERS OR IN BULK. CERTIFICATE SHALL STATE SOURCE, QUANTITY, OR WEIGHT, TYPE AND ANALYSIS AND DATE OF DELIVERY. DELIVER ALL CERTIFICATES TO THE LANDSCAPE ARCHITECT.
- NO SUBSTITUTIONS WILL BE PERMITTED WITHOUT THE APPROVAL OF THE OWNER OR LANDSCAPE ARCHITECT. REJECTED MATERIALS SHALL BE REMOVED FROM THE SITE BY THE LANDSCAPE CONTRACTOR.

1.04 TEST LABORATORY:

- A SOILS ANALYSIS OF EXISTING ON-SITE SOIL, IF REQUESTED WILL BE MADE AVAILABLE TO THE OWNER.
- AN ANALYSIS OF IMPORTED TOP SOIL AND ORGANIC SOIL AMENDMENTS IS REQUIRED PRIOR TO SHIPPING AND SHALL BE PERFORMED BY A QUALIFIED SOIL LAB AND THE RESULTS GIVEN TO THE LANDSCAPE ARCHITECT FOR APPROVAL.
- THE OWNER MAY ORDER FERTILITY TESTS OF SOIL PREPARATION AREAS, PREPARED BACKFILL MIX AREAS, AND IMPORT SOIL AREAS AFTER COMPLETION OF PLANTING TO ASSURE ALL SPECIFIED AMENDMENTS HAVE BEEN PROVIDED. TESTS SHALL BE PERFORMED BY A QUALIFIED SOIL LAB. (THE COST OF SOIL TESTS THAT FAIL SHALL BE BORNE BY THE LANDSCAPE CONTRACTOR).
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- NO SUBSTITUTIONS WILL BE PERMITTED WITHOUT THE APPROVAL OF THE OWNER OR LANDSCAPE ARCHITECT. REJECTED MATERIALS SHALL BE REMOVED FROM THE SITE BY THE LANDSCAPE CONTRACTOR.

1.05 PROTECTION:

- PROTECT THE OWNER'S PROPERTY FROM INJURY OR LOSS, ANY DAMAGE TO EXISTING PROPERTY (BUILDINGS, UTILITIES, ETC.) OR PLANTING (TREES, SHRUBS, LAWN OR GROUND COVER) CAUSED BY THE LANDSCAPE CONTRACTOR DURING HIS OPERATIONS OR AS A RESULT OF MALFUNCTION OF INSTALLED WORK DURING THE GUARANTEE PERIOD SHALL BE REPAIRED AT LANDSCAPE CONTRACTORS EXPENSE.
- CAUSE MINIMUM INTERFERENCE WITH WORKMEN, MATERIALS, OR OTHER EQUIPMENT OF OTHER TRADES ON THE PROJECT.

1.06 PALM TRUNKS:

- ALLOWABLE VARIATION IN TRUNK HEIGHT OF MEXICAN: 1/4". BROWN TRUNK HEIGHT (B.T.H.) IS DEFINED AS THE DISTANCE MEASURED FROM THE BASE OF THE PALM SOIL LINE AT THE TRUNK TO THE BASE OF THE LOWEST GREEN FROND.
- THE TRUNKS OF MEXICAN PALM SHALL BE CLEAN AND SKINNED TO WITHIN 1" OF HEART LEAF. AFTER SHEDDING, TRUNKS SHALL BE A MINIMUM OF 12" DIAMETER MEASURED AT 4" ABOVE ROOT CROWN AND HAVE A GENTLE TAPER UP TO THE HEAD OF THE TREE. TRUNKS OF CALIFORNIA PALM SHALL BE CLEAN AND SKINNED TO WITHIN 1" OF HEART LEAF. AFTER SHEDDING, TRUNKS SHALL BE A MINIMUM OF 12" DIAMETER MEASURED AT 4" ABOVE ROOT CROWN AND HAVE A GENTLE TAPER UP TO THE HEAD OF THE TREE. PALM TRUNKS WITH THINNER CALIPERS AND ELONGATED PETIOLES WILL NOT BE ACCEPTED. MECHANICAL SCARS WHICH PENETRATE INTO THE CONDUCTIVE TISSUE OF THE PALM TRUNK SHALL BE CAUSE FOR REJECTION OF THAT PALM TREE.

2.02 SOIL MATERIALS

- ORGANIC SOIL AMENDMENT SHALL BE GROUND ORGANIC MATERIAL, BIOLOGICALLY ACTIVE, COMPOSTED, 30% MINUS, PATHOGEN AND WEED FREE, AND ONE OF THE FOLLOWING OPTIONS ON APPROVED EQUIVALENT. LANDSCAPE CONTRACTOR SHALL SUBMIT 1 - QUART SAMPLES AND TWO (2) COPIES OF PRODUCT LITERATURE, LAB ANALYSIS AND REPORTS TO LANDSCAPE ARCHITECT FOR REVIEW AND APPROVAL.
- PLANTER MULCH (TOP DRESSING) SHALL BE SHEDDING DARK MULCH. MULCH SHALL BE GROUND ORGANIC MATERIAL, BIOLOGICALLY ACTIVE, COMPOSTED AND PATHOGEN AND WEED FREE. LANDSCAPE CONTRACTOR SHALL SUBMIT TWO (2) QUART SAMPLES AND TWO (2) COPIES OF PRODUCT LITERATURE, LAB ANALYSIS AND REPORTS TO LANDSCAPE ARCHITECT FOR REVIEW AND APPROVAL.
- PEAT MOSS SHALL BE SPERMATOPHYTES PEAT MOSS, CANADIAN OR EUROPEAN VARIETY, FREE FROM MOLD.
- COMMERCIAL FERTILIZERS SHALL BE COMPLETE FERTILIZERS 16-0-0, 17-15-0 OR OTHER BLENDINGS AS REQUIRED.
- FERTILIZER PLANTING TABLETS SHALL BE GROUND 7-GRAM TABLETS OR 1/2" X 1/2" X 1/2" PAKS FOR TREES, PALMS AND SHRUBS.
- GRO-POWER, GRO-GRO, AND GRO-POWER PLUS AS MANUFACTURED BY GRO-POWER (800) 393-3744. GRO-POWER PLUS AS MANUFACTURED BY TRO ENTERPRISES (800) 927-3311.

2.03 PLANT MATERIALS

- PLANT MATERIALS INCLUDING TREES, PALMS, SHRUBS AND GROUND COVERS SHALL BE FURNISHED BY THE LANDSCAPE CONTRACTOR IN THE QUANTITIES AND/OR SPACING AS SHOWN OR NOTED FOR EACH LOCATION AND SPECIES. TREES SHALL BE DELIVERED TO THE SITE UNQUANTIFIED AND/OR DESCRIBED IN THE PLANT MATERIAL LEGEND AND AS INDICATED ON THE DRAWINGS. THE LANDSCAPE ARCHITECT HAS PREPARED SET ONE (1) COPIES OF THE PLANT MATERIAL LEGEND. THE LANDSCAPE CONTRACTOR ASSUMES NO RESPONSIBILITY FOR ITS ACCURACY. THE LANDSCAPE CONTRACTOR SHALL BE RESPONSIBLE TO VERIFY ALL SIZES AND QUANTITIES DIRECTLY FROM THE PLANS.
- ALL PLANT MATERIALS SHALL BE HEALTHY, VIGOROUS, WITH A GOOD ROOT SYSTEM, AND SHALL BE FREE FROM INSECTS, VERMIN, PESTS OR DISEASE. ALL PLANT MATERIAL SHALL HAVE BEEN REVIEWED AND RELEASED BY THE COUNTY AGRICULTURAL COMMISSIONER TO DISTRIBUTE THE SOIL PLANT MATERIAL. SUPPLIER SHALL BE RESPONSIBLE TO COMPLY WITH THE REQUIREMENTS OF ANY AGRICULTURAL DEPARTMENT OR OTHER AGENCIES HAVING JURISDICTION OVER THE TRANSPORTATION OR CERTIFICATION OF PLANT MATERIAL BEING SUPPLIED TO THE PROJECT.
- CONTAINER STOCK SHALL HAVE GROWN IN CONTAINERS FOR AT LEAST 6 MONTHS, BUT NOT OVER 3 YEARS. SAMPLES SHALL BE SHOWN TO PROVE THAT NOT ROOT BOUND CONDITIONS PREVAIL. NO CONTAINER PLANTS THAT HAVE CRACKED OR BROKEN BALLS OF EARTH WHEN TUGGED FROM CONTAINERS SHALL BE PLANTED EXCEPT ON SPECIAL APPROVAL OF THE LANDSCAPE ARCHITECT.
- BALLED AND BURLAPPED STOCK IS TO BE PROVIDED WITH ROOTBALLS OF SUFFICIENT SIZE FOR THE VARIETY OF PLANT. HARVESTING SHALL OCCUR AT THE PROPER TIME OF YEAR AND ACCORDING TO BEST HORTICULTURAL PRACTICES FOR THE PARTICULAR VARIETY OF PLANT. ROOTBALLS ARE TO BE FULLY RELY COVERED WITH BURLAP AND SECURELY TIED. WHEN NECESSARY, WOOD PLATFORMS ARE TO BE PROVIDED TO SUPPORT ROOTBALLS.

IT SHALL BE THE LANDSCAPE CONTRACTOR'S RESPONSIBILITY TO COORDINATE WITH THE MATERIAL SUPPLIER THE DELIVERY OF ALL PLANTING MATERIAL TO THE SITE AND TO TRANSPORT AND PLACE MATERIAL TO THE FINAL LOCATION ON SITE INCLUDING ALL NECESSARY EQUIPMENT AND LABOR. PLANTS SHALL BE PROTECTED IN TRANSIT AND AFTER DELIVERY TO THE PROJECT SITE. PLANTS IN TRANSPORT CONTAINERS WILL NOT BE ACCEPTED, AND PLANTS WITH BROKEN BRANCHES OR BROKEN TRUNKS WILL BE REJECTED.

IT SHALL BE THE LANDSCAPE CONTRACTOR'S RESPONSIBILITY TO MAINTAIN PLANTS AFTER DELIVERY AND BE RESPONSIBLE TO THE SITE, REFER TO SECTION 3.14 GUARANTEE AND REPLACEMENT.

ALL GROUND COVERS SHALL BE FURNISHED BY THE LANDSCAPE CONTRACTOR IN QUANTITIES AND/OR SPACING AS INDICATED ON THE PLAN OR NOTED FOR EACH LOCATION AND SHALL BE OF SPECIES, TYPES, SIZES, ETC. AS SYMBOLIZED ON THE PLAN OR DESCRIBED IN THE PLANT MATERIAL LEGEND. GROUND COVERS SHALL BE APPROVED BY THE LANDSCAPE ARCHITECT AT THEIR NURSERY SOURCES PRIOR TO SHIPPING.

2.04 FIELD PROCURED PALMS:

FOLLOWING ARE THE REQUIREMENTS FOR PROCUREMENT OF FIELD GROWN MEXICAN PALM FRONDS AND "MEDJOL" DATE PALMS BE SUPPLIED TO THE PROJECT.

- CERTIFICATION: PALM SUPPLIERS SHALL PROVIDE CERTIFICATION, PRIOR TO SHIPPING, THAT THE PALMS ARE HEALTHY, PEST AND DISEASE FREE (SUCH AS THE DISEASE FUSARIUM) AND REPORT ON THE NUTRITIONAL STATUS OF THE PALM. TRUNKS SHALL BE FREE FROM SCARS, STEM CANKERS OR MECHANICAL INJURIES. THE CERTIFICATION IS TO BE COMPLETED BY AN APPROVED PATHOLOGIST AND SHALL BE SUPPLIED PRIOR TO SHIPMENT OF PALMS. A CERTIFICATE OF QUARANTINE COMPLIANCE, ISSUED BY THE APPLICABLE STATE AGRICULTURE DEPARTMENT FROM THE POINT OF ORIGIN SHALL ACCOMPANY THE PALM SHIPMENT.
- THE LANDSCAPE CONTRACTOR SHALL SUBMIT PHOTOGRAPHS OF THE PALM TREES TO THE LANDSCAPE ARCHITECT FOR REVIEW AND APPROVAL. DELIVERY MAY BEGIN UPON APPROVAL OF PHOTOGRAPHS. THE LANDSCAPE ARCHITECT MAY REJECT PALMS DETERMINED TO BE SUB-STANDARD.
- PALM TREES WILL BE INSPECTED WHEN THEY ARRIVE AT THE SITE BY THE LANDSCAPE ARCHITECT OR HIS AUTHORIZED REPRESENTATIVE. PALMS THAT HAVE BEEN DAMAGED DURING HANDLING AND SHIPPING AS DETERMINED BY THE LANDSCAPE ARCHITECT WILL BE REJECTED. IT WILL BECOME THE RESPONSIBILITY OF THE LANDSCAPE CONTRACTOR TO REMOVE THE REJECTED PALM TREES. THE LANDSCAPE CONTRACTOR SHALL BE REPLACED BY THE LANDSCAPE CONTRACTOR AT NO ADDITIONAL COST TO THE OWNER.

2.05 ROOTBALL REQUIREMENTS:

- REQUIREMENTS FOR MEXICAN PALM PALM ROOTBALLS:
MINIMUM ROOTBALL SIZE:
10" - 15" BROWN TRUNK 2 1/2" CURED
16" - 20" BROWN TRUNK 3" CURED
21" - 25" BROWN TRUNK 3 1/2" CURED
26" - 30" BROWN TRUNK 4" CURED
- REQUIREMENTS FOR DATE PALM ROOTBALLS:
MINIMUM ROOTBALL SIZE:
10" - 15" BROWN TRUNK 2 1/2" X 3" DEEP
16" - 20" BROWN TRUNK 3" X 4" X 3" DEEP
21" - 25" BROWN TRUNK 3 1/2" X 5" X 3" DEEP
26" - 30" BROWN TRUNK 4" X 5" X 3" DEEP
- REQUIREMENTS FOR CANARY ISLAND DATE PALM ROOTBALLS:
MINIMUM ROOTBALL SIZE:
10" - 15" B.T.H. 0" X 4" X 3" DEEP
16" - 20" B.T.H. 0" X 4" X 3" DEEP
21" - 25" B.T.H. 0" X 4" X 3" DEEP
26" - 30" B.T.H. 0" X 4" X 3" DEEP

WHEN CONDITIONS PERMIT, THE ROOTBALL SHALL BE DUG TO A DEPTH WHERE ROOTS END.

3.01 PALM TRUNKS:

- ALLOWABLE VARIATION IN TRUNK HEIGHT OF MEXICAN: 1/4". BROWN TRUNK HEIGHT (B.T.H.) IS DEFINED AS THE DISTANCE MEASURED FROM THE BASE OF THE PALM SOIL LINE AT THE TRUNK TO THE BASE OF THE LOWEST GREEN FROND.
- THE TRUNKS OF MEXICAN PALM SHALL BE CLEAN AND SKINNED TO WITHIN 1" OF HEART LEAF. AFTER SHEDDING, TRUNKS SHALL BE A MINIMUM OF 12" DIAMETER MEASURED AT 4" ABOVE ROOT CROWN AND HAVE A GENTLE TAPER UP TO THE HEAD OF THE TREE. TRUNKS OF CALIFORNIA PALM SHALL BE CLEAN AND SKINNED TO WITHIN 1" OF HEART LEAF. AFTER SHEDDING, TRUNKS SHALL BE A MINIMUM OF 12" DIAMETER MEASURED AT 4" ABOVE ROOT CROWN AND HAVE A GENTLE TAPER UP TO THE HEAD OF THE TREE. PALM TRUNKS WITH THINNER CALIPERS AND ELONGATED PETIOLES WILL NOT BE ACCEPTED. MECHANICAL SCARS WHICH PENETRATE INTO THE CONDUCTIVE TISSUE OF THE PALM TRUNK SHALL BE CAUSE FOR REJECTION OF THAT PALM TREE. EACH PALM SHALL HAVE A MINIMUM CALIPER OF 20 INCHES AND SHALL NOT VARY IN CALIPER MORE THAN 2 INCHES AT ANY POINT ALONG THE TRUNK.
- THE TRUNKS OF CANARY ISLAND DATE PALMS SHALL BE CLEAN, STRAIGHT AND OF CONSISTENT DIAMETER. REMNANT PETIOLES SHOULD BE REMOVED FROM THE TRUNK TO WITHIN 4" OF THE HEART LEAF. THE PALM TRUNK PETIOLE BASES THAT ARE REMAINING AT THE TOP OF THE TRUNK SHALL BE TAPERED IN ORDER THAT THEY ARE UNIFORM IN LENGTH AND APPEARANCE. MECHANICAL SCARS WHICH PENETRATE INTO THE CONDUCTIVE TISSUE OF THE PALM TRUNK SHALL BE CAUSE FOR REJECTION OF THAT PALM TREE.
- THE TRUNKS OF CANARY ISLAND DATE PALMS SHALL BE CLEAN, STRAIGHT AND OF CONSISTENT DIAMETER. REMNANT PETIOLES SHOULD BE REMOVED FROM THE TRUNK UP TO THE PETIOLE. THE HEADS SHALL BE "UNRAILED" AND NO FRONDS SHALL BE REMOVED ABOVE A HORIZONTAL LINE. REFER ALSO TO 10" BELT FOR ADDITIONAL INFORMATION REGARDING TRUNKING. MECHANICAL SCARS WHICH PENETRATE INTO THE CONDUCTIVE TISSUE OF THE PALM TRUNK SHALL BE CAUSE FOR REJECTION OF THAT PALM TREE. EACH PALM SHALL HAVE A MINIMUM CALIPER OF 20 INCHES AND SHALL NOT VARY IN CALIPER MORE THAN 2 INCHES AT ANY POINT ALONG THE TRUNK.

3.02 HARVESTING:

- ALL PALMS SHALL BE DUG BY HAND WITH A SHARP SPADY OR BY MACHINERY (TRENCHER SUCH AS A DITCH WIPER, ETC.). TRENCHING WITH A BACKHOE IS NOT ACCEPTABLE. WHENEVER POSSIBLE AND ESPECIALLY IN HAZARDOUS AREAS, TREES SHALL BE DUG TO WHERE THEIR ROOTS ARE FREE OF OIL OR ROOTS HANGING FROM THE ROOT BALL SHALL BE "SHAVED OFF" BY USE OF A SHARPENED SHOVEL. ANY TOOLS USED IN THE HARVESTING PROCESS, INCLUDING TRENCHERS, SHALL BE STERILIZED BETWEEN EACH PALM TREE VIA IMMERSION IN A SOLUTION OF 50% WATER AND 50% BLEACH.
- NO TREES SHALL BE REMOVED FROM ANY GIVEN FIELD LOCATION WITHOUT FOLLOWING THE PRESCRIBED ROOT BALL SIZE OR BY ANY OTHER MEANS OF EXCAVATION NOT OUTLINED IN THIS SECTION AND MUST BE APPROVED BY THE PLANT PATHOLOGIST BEFORE REMOVING TREES FROM THE PROJECT.
- WHILE EXCAVATING ROOT BALLS, ALL CONSIDERATION SHALL BE GIVEN IN KEEPING THE ROOT MASS INTACT AND IN A RELATIVELY MOIST CONDITION. ALL TREES SHALL BE THOROUGHLY RINSED PRIOR TO HARVEST. AMOUNT OF WATER REQUIRED TO RINSE SHALL BE DETERMINED BY THE WEIGHT OF THE ROOT MASS. NO TREES SHALL BE REMOVED FROM ANY GIVEN FIELD LOCATION WITHOUT FOLLOWING THE PRESCRIBED ROOT BALL SIZE OR BY ANY OTHER MEANS OF EXCAVATION NOT OUTLINED IN THIS SECTION AND MUST BE APPROVED BY THE PLANT PATHOLOGIST BEFORE REMOVING TREES FROM THE PROJECT.

3.03 PRUNING PROCEDURE:

- WHEN HARVESTING MEXICAN PALM FRONDS FROM THEIR NATIVE LOCATION, PRUNE THE FRONDS AS FOLLOWS:
WITH THE USE OF HAND LOPPERS AND HAND PRUNING SAWS, 30% (MAXIMUM) OF PALM FRONDS SHALL BE REMOVED DURING THE EXCAVATION PERIOD. NO TREE SHOULD HAVE ANY FROND CUT HIGHER THAN PARALLEL TO THE GROUND. ALL PALM FRONDS SHALL BE TIED IN AN UPRIGHT POSITION WITH 2-PLY TWINE. TWINE SHALL BE TIED HORIZONTALLY ACROSS PALM FRONDS. TWINE IS TO BE APPLIED TIGHT ENOUGH TO REMAIN TIED DURING ALL TRANSPORTING AND PLANTING PHASES OF WORK. PRUNING TOOLS INCLUDING, BUT NOT LIMITED TO, CHAINSAWS, LOPPERS, PRUNING SAWS, SHOVELS, GLOVES SHALL BE STERILIZED WITH A SOLUTION OF 50% WATER AND 50% BLEACH BETWEEN EACH PALM. IMMEDIATE CUTTING SURFACES IN THE CROWN SOLUTION AND ASHATE AFTER IMMERSION. RINSE TOOL WITH WATER THOROUGHLY. NO PALMS WITH CLIPPED FROND TIPS WILL BE ACCEPTED. REMOVE ANY FRUIT/FLOWER STEMS EXISTING ON THE PALM.

3.04 WHEN HARVESTING "MEDJOL" DATE PALMS FROM THEIR NATIVE LOCATION, PRUNE THE FRONDS AS FOLLOWS:

- WITH THE USE OF HAND LOPPERS AND HAND PRUNING SAWS, 30% (MAXIMUM) OF PALM FRONDS SHALL BE REMOVED DURING THE EXCAVATION PERIOD. NO TREE SHOULD HAVE ANY FROND CUT HIGHER THAN 30 DEGREES ABOVE PARALLEL TO THE GROUND. (FOURTY-4) A MINIMUM OF THREE (3) ROWS OF FRONDS BELOW THE CURRENT INFLORESCENCE OF FRUIT/FLOWER POSITION SHALL REMAIN ON THE TREE. REMOVAL OF RANDOM FRONDS TO FACILITATE CROWN TWINE IS UNACCEPTABLE. FRONDS FROM PHOENIX GENUS PALMS SHALL BE REMOVED AFTER PALMS ARE APPROVED AND CERTIFIED TO BE FREE OF DISEASE BY THE PATHOLOGIST. ALL PALM FRONDS SHALL BE TIED IN AN UPRIGHT POSITION WITH 2-PLY TWINE. TWINE SHALL BE TIED HORIZONTALLY ACROSS PALM FRONDS. TWINE IS TO BE APPLIED TIGHT ENOUGH TO REMAIN TIED DURING ALL TRANSPORTING AND PLANTING PHASES OF WORK. PRUNING TOOLS INCLUDING, BUT NOT LIMITED TO, CHAINSAWS, LOPPERS, PRUNING SAWS, SHOVELS, GLOVES SHALL BE STERILIZED WITH A SOLUTION OF 50% WATER AND 50% BLEACH BETWEEN EACH PALM. IMMEDIATE CUTTING SURFACES IN THE CROWN SOLUTION AND ASHATE AFTER IMMERSION. RINSE TOOL WITH WATER THOROUGHLY. NO PALMS WITH CLIPPED FROND TIPS WILL BE ACCEPTED. REMOVE ANY FRUIT/FLOWER STEMS EXISTING ON THE PALM.

3.05 DISEASE CONTROL:

- ALL PALM FRONDS REMAINING OF THE TREE SHALL BE SPRAYED WITH CLEARWAX 3333 AT THE RECOMMENDED RATE OR AN APPROVED EQUIVALENT PRODUCT RECOMMENDED BY THE PALM SPECIALIST PRIOR TO LOADING OF TREES FOR TRANSPORT TO THE SITE.

3.06 LOADING AND HANDLING OF PALMS:

- ALL TREES SHALL BE LOADED WITH BOOMS, HYDRAULIC OR CONVENTIONAL CRANES, FRONT LOADERS, BUCKETS, FORK LIFTS, OR TRACTORS SHALL NOT BE USED TO LOAD OR UNLOAD ANY PALM OVER EIGHT FEET OF BROWN TRUNK. NO CHAINS OR SHACKLED STEEL CHAINS SHALL BE CONSIDERED IN THE LOADING OR IN THE UNLOADING OF PALM TREES. RIGGING SHALL CONSIST OF THE HIGHEST QUALITY NYLON OR FABRIC RIGGING MATERIALS. MINIMUM 4" WITH THE USE OF SORTENERS, SHACKLES, CLEAVES, ETC. TO PREVENT DAMAGE TO STEM, BALL, OR DYNAMIC IS RECOMMENDED. PALMS SHALL BE PICKED HORIZONTALLY, RIGGED AT TWO POINTS, AND HANDLED IN SUCH A MANNER AS TO AVOID DYNAMIC (SHOCK) LOADS. ALL CONSIDERATION SHALL BE GIVEN IN THE SELECTION OF A LARGER GRADE TO FACILITATE LOADING, UNLOADING, AND SETTING. THIS CONSIDERATION SHALL VARY BASED ON ANY GIVEN SITE SITUATION AND IS SOLELY THE LIABILITY AND RESPONSIBILITY OF THE SUPPLIER AND HIS SUBCONTRACTORS.

3.07 BEFORE OFF-LOADING AND PLANTING PALMS, AFFIX FLAGGING TAPE TO THE NEAREST EMERGENCY STOP (OR NEAREST STOP) TO BETTER TRACK THE GROWTH OF THE PALM AFTER IT IS PLANTED.

3.08 K. BROADCASTING OF PALMS:

- ANY PALMS BEING TRANSPORTED ON STATE HIGHWAY SHALL MEET ALL LICENSING REQUIREMENTS AND ABIDE BY REGULATIONS CONCERNING ANY PARTICULAR REGION WHERE WORK IS BEING PERFORMED, INCLUDING, BUT NOT LIMITED TO, OVERLOAD PERMITS, OVER LENGTH PERMITS AND WIDE LOAD PERMITS. WATER PALMS AND ROOTBALLS THOROUGHLY BEFORE TRANSPORTING, AND IF TRANSPORT IS GREATER THAN 6 HOURS, THE TRUCK DRIVER SHALL SPRAY THE LEAVES AND ROOTBALL AT 4-HOUR INTERVALS DURING THE TRANSPORT.
- DOUBLE OR TRIPLE STACKING OF MEXICAN PALM FRONDS FOR TRANSPORT IS ACCEPTABLE. HOWEVER, EACH PALM HEAD/DOWN SHALL BE ACCURATELY SUPPORTED FROM BEHIND AND PROTECTED FROM BEING CRUSHED FROM ABOVE. ANY TREE HEAD THAT IS EXTENDED BEYOND THE TRAILER BED SHALL BE SUPPORTED WITH 2" X 4" BOARDS, 12 LENGTH, ONE BELOW AND ONE TOP OF THE TRUNK. THIS IS TO INSURE THAT THE TRUNK AND PALM HEAD DOES NOT BOUNCE AND CAUSE DAMAGE TO THE CROWN (STEM AREA).

3.09 L. PLANTING OR TRUCKED BY PALMS:

- PALMS MAY BE STORED AT A TEMPORARY SITE. HARVESTING, HANDLING AND TRANSPORTING SHALL BE AS SPECIFIED ABOVE.
- HARVESTED PALMS SHALL BE PLANTED IN THEIR PERMANENT LOCATION AT THE JOB SITE WITHIN 14 HOURS OF BEING HARVESTED. BACKFILL IS NOT POSSIBLE TO PLANT PALMS WHEN THEY ARE DELIVERED TO THE SITE. THEY SHALL BE "HEALED IN". UNLOADED AND PLANTED IN A PERPENDICULAR POSITION AND SPACED A MINIMUM OF 10' ON CENTER. FOR ANY PALMS "HEALED IN" AT A STORAGE FACILITY, PROVIDE DOCUMENTATION ON ORIGINAL DATE THE PALM WAS HARVESTED.

3.10 BOXED TREES:

- BOXED TREES ARE TO BE OF FIRST QUALITY, BOXED WITH APPROPRIATE SOIL MATURE TO SUPPORT SUCCESSFUL GROWTH. TREES SHALL HAVE BEEN HARDENED OFF IN THEIR BOXES FOR A MINIMUM OF 6 MONTHS. NO TREES WITH LOOSE OR BROKEN ROOTBALLS WILL BE ACCEPTED. TREES SHALL NOT HAVE BEEN GROWN IN THEIR BOXES SO LONG THAT ROOTS ARE GIRDLED OR ROOT BOUND. IF ROOTS HAVE GROWN OUT THROUGH THE BOTTOM OF THE BOX, NO TREES WITH SEVERED ROOTS GREATER THAN 1" IN DIAMETER WILL BE ACCEPTED.
- TREES WILL BE INSPECTED WHEN THEY ARRIVE AT THE SITE BY THE LANDSCAPE ARCHITECT OR HIS AUTHORIZED REPRESENTATIVE. TREES THAT HAVE BEEN DAMAGED DURING HANDLING AND SHIPPING AS DETERMINED BY THE LANDSCAPE ARCHITECT WILL BE REJECTED. IT WILL BECOME THE RESPONSIBILITY OF THE CONTRACTOR TO REMOVE THE REJECTED TREES FROM THE SITE. REJECTED TREES SHALL BE REPLACED BY THE LANDSCAPE CONTRACTOR AT NO ADDITIONAL COST TO THE OWNER.

3.11 C. ALL TREES SHALL BE LOADED WITH BOOMS, HYDRAULIC OR CONVENTIONAL CRANES, FRONT LOADERS, BUCKETS, FORK LIFTS, OR TRACTORS CAN ONLY BE USED WHEN LOADING TREES IN BOXES AND SHALL NOT COME IN CONTACT WITH TREE TRUNK. ALL CONSIDERATION SHALL BE GIVEN FOR THE USE OF NYLON OR FABRIC RIGGING WHILE LOADING TREES. IF CRANES ARE USED, THEY SHALL NOT COME IN CONTACT WITH THE TREE TRUNK. ANY TREES BEING TRANSPORTED ON STATE HIGHWAYS SHALL MEET THE LICENSING REQUIREMENTS AND ABIDE BY REGULATIONS GOVERNING ANY PARTICULAR REGION WHERE WORK IS BEING PERFORMED, INCLUDING, BUT NOT LIMITED TO, OVERLOAD PERMITS, OVER LENGTH AND WIDE LOAD PERMITS. WATER ROOTBALLS THOROUGHLY BEFORE TRANSPORTING, AND IF TRANSPORT IS GREATER THAN 6 HOURS, THE TRUCK DRIVER SHALL SPRAY THE FOLIAGE AND ROOTBALLS AT 4-HOUR INTERVALS DURING THE TRANSPORT. TREES SHALL BE PROTECTED DURING TRANSIT. TREES SHALL BE FULLY TAPED AND PROTECTED INCLUDING BLOCKING AND SUPPORTS FOR HEADS, TRUNKS AND ROOTBALLS. NO STACKING OF TREE ROOTBALLS OR BOXES WILL BE PERMITTED. TREES IN BOXES SHALL HAVE THE TOPS OF THE ROOTBALLS PROTECTED BY MEANS OF INSTALLING TOP PRODDING.

3.12 D. BOXED TREES SHALL BE OF THE SIZES, DIMENSION, FORM ETCETERA AS NOTED IN THE TREE LEGEND ON THE PLANTING PLANS.

- THE LANDSCAPE CONTRACTOR SHALL SUBMIT PHOTOGRAPHS OF THE TREES TO THE LANDSCAPE ARCHITECT FOR REVIEW AND APPROVAL OF THE TREES. PHOTOGRAPHS SHALL BE SUBMITTED PRIOR TO THE MATERIAL BEING SHIPPED TO THE SITE.

3.13 F. AFTER APPROVAL OF THE PHOTOGRAPHS THE LANDSCAPE ARCHITECT RESERVES THE RIGHT TO REVIEW THE TREES AT THE SUPPLIER, BASED ON THE DRAWINGS. THE LANDSCAPE ARCHITECT MAY REJECT TREES DETERMINED TO BE SUB-STANDARD.

2.05 MISG. LANDSCAPE MATERIALS

H. TREE STAKING AND GUYING MATERIALS:

- WOODEN TREE STAKES SHALL BE ROUGH CONSTRUCTION HEART REDWOOD OR SHINKAPINE LUMBER POLE PINE, AT LEAST 1 1/2" X 12' REDWOOD, 2" DIAMETER LOGS POLE, ACTUAL DIMENSION NOT LESS THAN 8' LONG, FREE FROM LOGS, KNOTS, SPLITS OR BENDS, POINTED AT ONE END. LOGS POLE PINE TREE STAKES ARE TO BE FULL LENGTH DRY-TREATED WITH COPPER NAPHTHAMIDE IN ACCORDANCE WITH FEDERAL SPECIFICATION T-11-372, TYPE I, COMPOSITE TYPE B.

I. GUY WIRES FOR GUYING TREES SHALL BE 12-GAUGE GALVANIZED, ANNEALED WIRE. COVER FOR WIRE SHALL BE REINFORCED GREEN RUBBER GARDEN HOSE, 3/4" DIAMETER, 10' LONG. STAYED FOR GUY WIRES SHALL BE REDWOOD 2" X 2" X 12' OR STEEL CORE DEADMAN STAKES AVAILABLE FROM J.C.T. COMPANY, INC. (881) 269-4453.

J. STRAPS FOR USE IN TREE STAKING SHALL BE "TREESTRAPS" NO. 1018 AVAILABLE FROM GELCO, INC. (800) 393-3584. STRAPS FOR USE IN TREE GUYING SHALL BE "TREESTRAPS" NO. 2224 AVAILABLE FROM GELCO, INC. (800) 393-3584.

K. ROOT BARRIERS: ROOT BARRIERS SHALL BE POLYETHYLENE PLASTIC, .085 THICK NO. CP 242 AND CP 182 AS MANUFACTURED BY GENTURY PRODUCTS (800) 400-5004 (OR APPROVED EQUIVALENT). INSTALL BARRIERS PER MANUFACTURERS' DETAILS AND SPECIFICATIONS. INSTALL ROOT BARRIERS WITH NATIVE SOIL BACKFILL.

L. ALUMINUM HEADERS: ALUMINUM ENDING SHALL BE 2" X 3/4" X 3/4" MILL FINISH AS MANUFACTURED BY PERMALCO (800) 393-3584 (OR APPROVED EQUIVALENT). INSTALL ENDING PER MANUFACTURERS' DETAILS AND SPECIFICATIONS AND AS DETAIL ON THE PLANS.

M. TURF BLOCK: TURF BLOCK SHALL BE "TURFTRAC" GRASS PAVERS AS MANUFACTURED BY N.D.S. (800) 785-1081 (OR APPROVED EQUIVALENT). INSTALL TURF BLOCK PER MANUFACTURERS' DETAILS AND SPECIFICATIONS AND AS DETAIL ON THE PLANS.

N. PLASTIC HEADER: PLASTIC HEADER SHALL BE "BENCO-BOARD" 1" X 4" PLASTIC HEADER BOARD, REDWOOD BROWN COLOR, AS MANUFACTURED BY ERIC PLASTICS (800) 225-5559 OR APPROVED EQUIVALENT. INSTALL PLASTIC HEADER BOARD PER MANUFACTURERS' DETAILS AND SPECIFICATIONS AND AS DETAIL ON THE PLANS.

O. POTTERY: POTTERY SHALL BE AS SPECIFIED ON THE PLANS INCLUDING THE STYLE, SIZE, COLOR AND FINISH. THE CONTRACTOR SHALL SUBMIT PHOTOGRAPHS OF POTTERY SAMPLES TO THE LANDSCAPE ARCHITECT FOR REVIEW AND APPROVAL. IF IT IS DETERMINED THAT SOIL DRAINAGE IS A PROBLEM A RESOLUTION WILL BE WORKED OUT BY THE OWNER AND LANDSCAPE ARCHITECT IF NECESSARY A CHANGE ORDER WILL BE INITIATED.

P. ALL PLANTS SHALL BE PLANTED IMMEDIATELY AFTER THEY ARE REMOVED FROM CONTAINERS AND CONTAINERS SHALL BE REGULARLY REMOVED FROM THE AREA OF WORK AND DISPOSED OF SO AS NOT TO PRESENT A HAZARD TO THOSE PERSONS USING THE AREAS.

Q. SET PLANTS IN CENTER OF FITS, IN A VERTICAL POSITION SO THAT THE CROWN OF THE PLANT WILL BE IN THE SAME RELATIONSHIP TO THE FINISH GRADES THAT IT IS TO SOIL. SURFACE IN PLACE OF GROWTH, ALLOWING FOR WATERING AND SETTLING OF SOIL.

R. BACKFILL WITH SPECIFIED SOIL MIX. INSTALL FERTILIZER-PLANTING TABLETS IN PLANTING PIT AS SHOWN IN PLANTING DETAILS. QUANTITY OF TABLETS SHALL BE PER MANUFACTURERS' SPECIFICATIONS. BACKFILL SHALL BE AS SPECIFIED ON THE PLANS. NO FILLING SHALL BE PERMITTED AROUND THE TRUNK OF THE PLANTS.

S. PLANTS SHALL BE WATERED AS THEY ARE PLANTED AND BASINS SHALL BE BUILT AROUND EACH PLANT TO RETAIN WATER. REMOVE BASINS PRIOR TO TOP DRESSING.

T. GRADE AREAS AROUND PLANTS TO FINISH GRADES AND DISPOSE OF EXCESS SOIL.

U. PRUNE PLANTS ACCORDING TO STANDARD HORTICULTURAL PRACTICE AS DIRECTED BY LANDSCAPE ARCHITECT.

V. UPON COMPLETION OF ALL PLANTING OPERATIONS AND AGAIN AS A REQUIREMENT, JUST PRIOR TO THE CONSTRUCTION BEGINS, ALL SOIL BETWEEN PLANTS SHALL BE LIGHTLY CULTIVATED, WEEDED, AND NEATLY RAKED.

3.09 PLANTING TREES AND PALMS

A. EACH TREE AND PALM LOCATION SHALL BE STAKED IN THE FIELD FOR THE TREE PLANS BY THE LANDSCAPE CONTRACTOR USING MINIMUM 1/2" LONG STAKES. THE TOP 2" OF EACH STAKE SHALL BE PAINTED WITH A DIFFERENT COLOR OF PAINT FOR EACH TREE OR PALM SPECIES. STAKE LONG ENOUGH TO BE EASILY LOCATED BY THE LANDSCAPE ARCHITECT PRIOR TO EXCAVATION OF PLANTING PITS. STAKES SHALL BE LOCATED IN THE FIELD BY THE LANDSCAPE CONTRACTOR FOR REVIEW AND APPROVAL BY THE LANDSCAPE ARCHITECT PRIOR TO ARRIVAL OF LANDSCAPE ARCHITECT AT THE SITE. REFER TO "CONSTRUCTION REVIEW" SECTION 3.14.

B. PREPARE PLANTING PITS AS SPECIFIED ABOVE, UNLESS OTHERWISE NOTED IN DETAILS.

C. TREES PLANTED IN PLANTERS ON STRUCTURAL DECK SHALL BE BACKFILLED WITH LIGHTWEIGHT SOIL MIX AND THOROUGHLY WATER SETTLED.

D. PLACE THE TREE AND BACKFILL WITH PREPARED BACKFILL MIX AS SPECIFIED ABOVE, THOROUGHLY WATER SETTLED.

E. STAKE TREES AS DETAIL ON THE DRAWINGS.

F. KEEP GUY WIRES OUT OF GENERAL PEDESTRIAN TRAFFIC AREAS WHENEVER POSSIBLE.

G. FIELD PROCURED PALM TREES:

- ALL TREES SHALL BE LOADED WITH BOOMS, HYDRAULIC OR CONVENTIONAL CRANES, FRONT LOADERS, BUCKETS, FORK LIFTS, OR TRACTORS SHALL NOT BE USED TO LOAD OR UNLOAD ANY PALM OVER EIGHT FEET OF BROWN TRUNK. NO CHAINS OR SHACKLED STEEL CHAINS SHALL BE CONSIDERED IN THE LOADING OR IN THE UNLOADING OF PALM TREES. ALL RIGGING SHALL CONSIST OF THE HIGHEST QUALITY NYLON OR FABRIC RIGGING MATERIALS. MINIMUM 4" WITH THE USE OF SORTENERS, SHACKLES, CLEAVES, ETC. TO PREVENT DAMAGE TO STEM, BALL, OR RIGGING IS RECOMMENDED. PALMS SHALL BE PICKED HORIZONTALLY, RIGGED AT TWO POINTS, AND HANDLED IN SUCH A MANNER AS TO AVOID DYNAMIC (SHOCK) LOADS. ALL CONSIDERATION SHALL BE GIVEN IN THE SELECTION OF A LARGER GRADE TO FACILITATE LOADING, UNLOADING, AND SETTING. THIS CONSIDERATION SHALL VARY BASED ON ANY GIVEN SITE SITUATION AND IS SOLELY THE LIABILITY AND RESPONSIBILITY OF THE SUPPLIER AND HIS SUBCONTRACTORS.

H. BEFORE OFF-LOADING AND PLANTING PALMS, AFFIX FLAGGING TAPE TO THE NEAREST EMERGENCY STOP (OR NEAREST STOP) TO BETTER TRACK THE GROWTH OF THE PALM AFTER IT IS PLANTED.

I. PLANTING REQUIREMENTS FOR PALMS: ALL PLANTING PITS FOR PALM TREES SHALL BE A MINIMUM OF TWO FEET GREATER THAN ANY SIDE OF THE ROOT BALL AND ONE FOOT DEEPER. AUGER A 12" DIAMETER BY 10" DEEP DRAINAGE HOLE IN THE BOTTOM OF THE PLANTING PIT AND BACKFILL WITH WASHED CORNIE GRAVEL. REFER TO PALM PLANTING DETAIL FOR ADDITIONAL INFORMATION REGARDING PLANTING PITS.

J. BACKFILL: A MIXTURE OF 100% WASHED CONCRETE SAND SHALL BE USED AS BACKFILL. TREES SHALL BE PLANTED PERPENDICULAR TO GRADE AND PLANTED UNDER THE DIRECTION OF THE LANDSCAPE ARCHITECT. AFTER PLANTING, IN FINISHED GRADES OTHER THAN A LEVEL CONDITION, TREES SHALL BE SET IN ORDER THAT THE ROOT CROWNS ARE AT DIFFERENT ELEVATIONS. THE SAND BACKFILL SHALL BE APPLIED IN LAYERS AND JETTED WITH WATER AND THE USE OF A HIGH-PRESSURE NOZZLE AND HOSE. AT LEAST ONE COMPACTOR MAY BE ACHIEVED WITH THE ASSISTANCE OF INFLUENTIAL TAMPERS. THOROUGHLY WATER PALM PLANTING PIT IMMEDIATELY AFTER PLANTING AND ENSURE THAT PALM ROOTBALL IS SATURATED WITH WATER. ANY ADJUSTMENTS NECESSARY TO STRAIGHTEN PALMS DUE TO POOR COMPACT WITHIN 10 MONTHS AFTER FINAL ACCEPTANCE OF PROJECT SHALL BE MADE BY THE LANDSCAPE CONTRACTOR AT NO CHARGE TO THE OWNER.

K. PLANTING OR "HE

3.07 PLANTING SHRUBS AND VINES

- PREPARE SHRUB PITS AS SPECIFIED UNDER SECTION 3.05 ABOVE, "GENERAL PLANTING".
- PLANTING PROCEDURES AND PRACTICES SHALL GENERALLY BE THE SAME AS THOSE INDICATED UNDER SECTION 3.06 ABOVE, "PLANTING TREES".
- ALL TRELLISES AND STAKES SHALL BE REMOVED FROM VINE AND ESPALIER PLANTS AND THE PLANTS SHALL BE FASTENED AND TRAINED AGAINST FENCES OR WALLS AS CALLED FOR ON THE PLAN, SHOWN IN PLANTING DETAILS OR DIRECTED BY THE LANDSCAPE ARCHITECT.

3.08 GROUND COVER, TURF AND SEASONAL COLOR PLANTING

- GRADE GROUND COVER AREAS TO FINISH GRADES SPECIFIED UNDER SECTION 3.06 ABOVE. FINISH GRADES SHALL MEET APPROVAL OF LANDSCAPE ARCHITECT PRIOR TO SOIL PREPARATION.
- PREPARE GROUND COVER AREAS AS SPECIFIED UNDER "SOIL PREPARATION" SECTION 3.01.

- GROUND COVER AREAS SHALL BE MULCHED IN CONFORMANCE WITH SPECIFICATIONS AND WATERED WITH LIGHT SPRINKLY.
- SMOOTH SOIL ABOUT PLANTS AND LEAVE AREAS IN NEAT AND CLEAN CONDITION. DO NOT PILE SOIL OR MULCH AROUND CROWN OF ANY PLANTS.

3.09 INSTALL TURF (SOIL) PER SOO GROWERS SPECIFICATIONS.

3.09 POTTERY

- INSTALL POTTERY AT LOCATIONS SHOWN ON THE CONSTRUCTION PLANS INCLUDING THE INSTALLATION OF DRAINAGE, SOIL, PLANT MATERIALS AND IRRIGATION. REFER TO CONSTRUCTION PLANS FOR INSTALLATION DETAILS AND OTHER INFORMATION PERTAINING TO POTTERY.
- THE LANDSCAPE CONTRACTOR SHALL BE RESPONSIBLE TO COORDINATE WITH THE WORK OF OTHER TRADES INCLUDING BUT NOT LIMITED TO LIGHTING, PAINTING, FABRIC, CONCRETE, ELECTRICAL AND ORNAMENTAL IRON.

3.10 FERTILIZATION AFTER PLANTING

- ALL PLANTING AREAS SHALL RECEIVE AN APPLICATION OF ORG-POWER AT THE RATE OF TWENTY-FIVE LBS. PER 1,000 SQUARE FEET THIRTY DAYS AFTER PLANTING.
- FERTILIZER APPLICATION SHALL BE REPEATED AT THIRTY-DAY INTERVALS UNTIL THE END OF MAINTENANCE PERIOD.

- SHRUBS/GROUND COVER - APPLY SUPPLEMENTAL FERTILIZER TO PROVIDE A HEALTHY COLOR IN ALL SHRUBS AND GROUND COVER. SURFACIAL FERTILIZER SHOULD BE NITROGENIC AND GRANULAR IN FORM WITH MICRONUTRIENTS.
- ALL SEASONAL COLOR BEDS/GRADES SHALL BE FERTILIZED IMMEDIATELY AFTER PLANTING. APPLY "FLOWERSNOW" (AS MANUFACTURED BY ORG-POWER) AT THE RATE OF 25 LBS. PER 1,000 S.F.

- MULCHING: ALL SHRUB PLANTING AREAS IN GRADE PLANTINGS ONLY SHALL RECEIVE A LAYER OF PREPARED TOP DRESSING SPREAD EVENLY OVER THE SURFACE TO A MINIMUM DEPTH OF TWO INCHES (2"). PREPARED TOP DRESSING SHALL BE SPREADED DARK MULCH OR APPROVED EQUIVALENT. LANDSCAPE CONTRACTOR SHALL SUBMIT SAMPLE TO LANDSCAPE ARCHITECT FOR REVIEW AND APPROVAL.

3.12 MAINTENANCE PERIOD

- CONTINUOUSLY MAINTAIN ALL AREAS INCLUDED UNDER THIS SECTION AND "IRRIGATION SYSTEM" SECTION DURING THE PROGRESS OF THE WORK. THE MAINTENANCE PERIOD, AND UNTIL FINAL ACCEPTANCE OF THE WORK, MAINTENANCE SHALL CONTINUE FOR NINETY (90) DAYS OR UNTIL FINAL ACCEPTANCE OF THE WORK.
- IF PLANTINGS ARE NOT ACCEPTABLE AS DETERMINED BY THE LANDSCAPE ARCHITECT OR OWNER AT THE COMPLETION OF THE WORK, DUE TO DEFECTIVE MAINTENANCE, MAINTENANCE SHALL BE CONTINUED UNTIL ALL WORK MEETS SPECIFICATIONS AND CAN BE APPROVED.

- MAINTENANCE SHALL INCLUDE CONTINUOUS OPERATIONS OF WATERING, WEEDING, MOWING, ROLLING, TRIMMING, EDGING, CULTIVATION, FERTILIZING, SPRAYING FOR INSECT AND PEST CONTROL, RESEEDING, GERMINATION AND/OR ANY OTHER OPERATIONS NECESSARY TO ASSURE GOOD NORMAL GROWTH. APPLY LAWN MOWING CONTROL SPRAYS OR OTHER MATERIALS, AS OFTEN AS MAY BE REQUIRED TO PROTECT LAWN AND TURF UNTIL FINAL ACCEPTANCE OF THE WORK.

- ALL PLANTED AREAS SHALL BE FREE FROM WEEDS AND SHALL BE WATERED AND WEEDED AT NO MORE THAN TEN DAY INTERVALS.
- WATERING - SINCE WATER REQUIREMENTS FOR PLANTS VARY ACCORDING TO THE SEASON AND A PARTICULAR YEAR, EXTREMELY CLOSE ATTENTION SHALL BE PAID TO THE DEMANDS OF THE PLANTS AS INFLUENCED BY THEIR EXPOSURE TO SUN, WIND, SHADE, AND LOCATION IN THE INDIVIDUAL PLANTINGS. THE VARIATION IN THE SIZE OF PLANTS INSTALLED, AS WELL AS THE VARIETIES, SHALL BE TAKEN INTO CONSIDERATION. ALL LANDSCAPED AND TURF AREAS SHALL BE IRRIGATED AS REQUIRED TO MAINTAIN ADEQUATE GROWTH AND APPEARANCE WITH A SCHEDULE MOST CONSIDERATE TO PLANT GROWTH. THE DELIVERY OF ADEQUATE MOISTURE TO THE LANDSCAPED AREAS SHALL INCLUDE, BUT NOT BE LIMITED TO, HAND WATERING, PROPER UTILIZATION OF AUTOMATIC CONTROLS, AND THE DRINKING OF VALVES. CONTRACTOR SHALL PERFORM CHECK FOR ADEQUATE SOIL MOISTURE ONE TIME PER WEEK WITH A SOIL PROBE. CHECK SOIL MOISTURE AT A MINIMUM OF ONE LOCATION PER IRRIGATION VALVE SYSTEM AND SUPPLEMENT WATER AS REQUIRED.

- DURING INSTALLATION PERIOD AND DURING MAINTENANCE PERIOD, THE LANDSCAPE CONTRACTOR SHALL BE RESPONSIBLE FOR MAINTAINING ADEQUATE PROTECTION OF ALL AREAS. ANY DAMAGED PLANTINGS SHALL BE REPAIRED AT THE LANDSCAPE CONTRACTOR'S EXPENSE.

- AT THE COMPLETION OF LANDSCAPE INSTALLATION AND MAINTENANCE PERIOD, ALL PLANT MATERIALS SHALL BE LIVE, HEALTHY, UNDEMANAGED AND FREE OF INFESTATIONS AS DETERMINED BY THE LANDSCAPE ARCHITECT. INTERIOR PLANTING SHALL BE REPLACED AND BROUGHT TO A SATISFACTORY CONDITION BEFORE FINAL ACCEPTANCE OF WORK WILL BE MADE. ALL AREAS SHALL BE NEATLY RAKED AND FREE OF WEEDS.

- REPLACEMENTS: IMMEDIATELY REPLACE ANY AND ALL PLANT MATERIALS AND GRASS THAT DIE OR ARE DAMAGED. REPLACEMENTS SHALL BE MADE TO SAME SPECIFICATIONS AS REQUIRED FOR ORIGINAL PLANT.

- TWO (2) CONSTRUCTION REVIEWS SHALL BE MADE THAT AFFECT THE MAINTENANCE PERIOD. THE FIRST AFTER ALL PLANTING HAS BEEN COMPLETED, INSTALLED IN ORDER TO APPROVE THE BEGINNING OF THE MAINTENANCE PERIOD OF NOT LESS THAN NINETY (90) CALENDAR DAYS AND THE SECOND AT THE END OF THE NINETY-DAY MAINTENANCE PERIOD. IF PLANTINGS ARE NOT ACCEPTABLE AT THE END OF THE NINETY-DAY PERIOD, DUE TO DEFECTIVE MAINTENANCE, THEN MAINTENANCE SHALL BE CONTINUED BY THE LANDSCAPE CONTRACTOR UNTIL WORK MEETS WITH THE SPECIFICATIONS AND CAN BE APPROVED. WRITTEN NOTICE, REQUESTING THE FIRST REVIEW SHALL BE SUBMITTED BY THE LANDSCAPE CONTRACTOR AT LEAST SEVEN (7) CALENDAR DAYS BEFORE THE ANTICIPATED DATE OF REVIEW.

- CONSTRUCTION REVIEWS ALL REVIEWS HEREIN SPECIFIED SHALL BE MADE BY THE LANDSCAPE ARCHITECT. THE LANDSCAPE CONTRACTOR SHALL REQUEST THE REVIEW AT LEAST 48 HOURS IN ADVANCE OF THE TIME THE REVIEW IS DESIRED. REVIEWS ARE REQUIRED AS FOLLOWS:

- CONTRACTOR ORIENTATION/RECONSTRUCTION MEETING: THIS MEETING SHALL BE CONDUCTED TO DISCUSS THE PLANS AND SPECIFICATIONS, POSSIBLE DISCREPANCIES, SITE CONDITIONS AND OTHER ASPECTS OF THE PROJECT. LANDSCAPE WORK SUCH AS PERSONALITIES, SCHEDULE AND REQUIREMENTS FOR STARTING WORK. PRIOR TO MEETING, THE LANDSCAPE CONTRACTOR SHALL THOROUGHLY ACQUAINT HIMSELF WITH THE CONDITIONS AND THE PLANS, DETAILS AND SPECIFICATIONS.

- THE MEETING SHALL BE ATTENDED BY, AS A MINIMUM, THE PROJECT MANAGER AND FIELD FOREMAN FOR THIS PROJECT FROM THE LANDSCAPE CONTRACTOR.

- WHEN TREE AND PALM LOCATIONS HAVE BEEN STAKED PER 3.06A.
- WHEN PLANT MATERIAL (SHRUBS, VINES AND SEASONAL COLOR) HAS BEEN SPOTTED FOR PLANTING BUT BEFORE PLANTING AREAS ARE EXCAVATED.

- THE LANDSCAPE CONTRACTOR SHALL BE REQUIRED TO HAVE A COMPLETE REVIEW AND APPROVAL OF ALL LANDSCAPE CONSTRUCTION ITEMS AT THE END OF THE LANDSCAPE CONSTRUCTION PERIOD, TO ESTABLISH THE TIME FOR BEGINNING OF THE MAINTENANCE PERIOD. NOTIFY LANDSCAPE ARCHITECT AT LEAST SEVEN (7) DAYS IN ADVANCE OF REVIEW.

- IN ORDER TO OBTAIN FINAL APPROVAL AT THE COMPLETION OF THE MAINTENANCE PERIOD, A REVIEW BY THE LANDSCAPE ARCHITECT SHALL BE REQUIRED. NOTIFY THE LANDSCAPE ARCHITECT AT LEAST 24 HOURS IN ADVANCE OF REVIEW.

- IN THE EVENT THE LANDSCAPE CONTRACTOR CALLS FOR A REVIEW WITHOUT COMPLETING PREVIOUSLY NOTED CORRECTIONS, OR WITHOUT PREPARING THE WORK FOR REVIEW, HE SHALL BE RESPONSIBLE FOR REIMBURSING THE LANDSCAPE ARCHITECT AT THE NORMAL OFFICE HOURLY RATE PER HOUR PORTAL TO PORTAL (PLUS TRANSPORTATION COSTS) FOR THE INCORPORATION. NO FURTHER REVIEWS WILL BE SCHEDULED UNTIL THIS CHANGE HAS BEEN PAID.

- GUARANTEE AND REPLACEMENT: SUBMIT A WRITTEN GUARANTEE IN AN APPROVED FORM IN COMPLIANCE WITH THE RELATED REQUIREMENTS OF GENERAL CONDITIONS GUARANTEEING THE WORK OF THE SECTION AGAINST ANY DEFECTIVE MATERIALS AND WORKMANSHIP IN COMPLIANCE WITH THE FOLLOWING TERMS, AGREEING TO REPLACE ANY DEFECTIVE MATERIALS AND/OR WORKMANSHIP AT NO ADDITIONAL COST TO THE OWNER.

- TREES AND PALMS SHALL BE GUARANTEED FOR A PERIOD OF TWO YEARS AND SHRUBS, VINES, AND GROUND COVER FOR A PERIOD OF SIX MONTHS AFTER FINAL APPROVAL AND ACCEPTANCE. (FINAL APPROVAL AND ACCEPTANCE SHALL BE THE SAME AS THE END OF THE MAINTENANCE PERIOD).

- ANY PLANT MATERIAL WHICH DIES OR WHICH IS NOT HEALTHY OR VIGOROUS WHEN IT HAS RECEIVED NORMAL CARE AND MAINTENANCE AS DETERMINED BY THE LANDSCAPE ARCHITECT SHALL BE REPLACED WITHIN OR AT THE END OF THE GUARANTEE PERIOD WITH PLANTS EQUAL IN SIZE TO THE ORIGINAL.
- ANY TREES OR OTHER PLANT MATERIALS THAT DIE-BACK AND LOSE THE FORM AND SIZE AS ORIGINALLY SPECIFIED AS DETERMINED BY THE LANDSCAPE ARCHITECT SHALL BE REPLACED EVEN THOUGH THEY HAVE TAKEN ROOT AND ARE GROWING AFTER THE DIE-BACK.
- THE LANDSCAPE CONTRACTOR, WHEN NOTIFIED BY THE OWNER SHALL REMOVE AND REPLACE ALL GUARANTEED PLANT MATERIALS, WHICH FOR ANY REASON FAIL TO MEET THE REQUIREMENTS OF THE GUARANTEE. REPLACEMENT OF MATERIAL AND PLANTS SHALL BE MADE TO SAME SPECIFICATIONS AS REQUIRED FOR ORIGINAL PLANTING, AND ALL REPLACEMENTS SHALL BE GUARANTEED AS SPECIFIED FOR ORIGINAL MATERIALS.

- CLEAN UP: UPON COMPLETION OF LANDSCAPE CONSTRUCTION AND BEFORE FINAL ACCEPTANCE, REMOVE RUBBISH, TRASH AND DEBRIS RESULTING FROM LANDSCAPE CONSTRUCTION OPERATION. THE SITE SHALL BE LEFT IN A NEAT AND ACCEPTABLE CONDITION SUCH AS TO MEET APPROVAL OF THE LANDSCAPE ARCHITECT.

TREE SALVAGE AND PRESERVATION SPECIFICATIONS

PART 1 - GENERAL

1.01 WORK COVERED

- THE WORK UNDER THIS SECTION SHALL INCLUDE ALL LABOR, MATERIALS, AND EQUIPMENT REQUIRED TO COMPLETE ALL THE TREE AND PALM SALVAGE AND PRESERVATION WORK AS INDICATED ON THE DRAWINGS AND AS SPECIFIED HEREIN. WORK INCLUDES, BUT IS NOT LIMITED TO, THE FOLLOWING:

- PROTECTION OF EXISTING TREES AND PALMS CALLED OUT TO REMAIN IN PLACE.
- SALVAGE OF EXISTING TREES AND PALMS CALLED OUT TO BE RELOCATED.
- REMOVAL AND DISPOSAL OF EXISTING TREES AND PALMS CALLED OUT TO BE DEMOLISHED.

- SET-UP AND MAINTENANCE OF HOLDING NURSERY.
- PREPARATION OF PROGRAM FOR ALL PHASES OF SALVAGE OPERATION.
- TEMPORARY STAKING OR GUYING OF TREES AND PALMS.

- PROTECTION, MAINTENANCE AND GUARANTEE AS SPECIFIED.
- ALL WORK OF EVERY DESCRIPTION MENTIONED IN THE SPECIFICATIONS AND/OR AMENDMENTS THEREON, AND ALL OTHER SATISFACTORY COMPLETION OF THE WORK AS DETERMINED BY THE OWNER INCLUDING CLEAN UP OF THE SITE.

- THE TREE SALVAGE CONTRACTOR SHALL COORDINATE WITH THE GENERAL CONTRACTOR, AND OTHER SUB-CONTRACTORS AS REQUIRED TO PROPERLY COMPLETE THEIR WORK.
- PREPARATION AND SUBMITTAL OF SCHEDULES FOR ALL PHASES OF WORK IN ORDER TO COMPLETE TO COMPLETE WORK ACCORDING TO THE GENERAL CONTRACTOR'S CONSTRUCTION SCHEDULE.

1.02 RELATED WORK IN OTHER SECTIONS

- EXAMINE ALL SECTIONS FOR WORK RELATED TO WORK OF THIS SECTION. LANDSCAPE PLANTING, REFER TO SHEET L2.00.

- DRAWINGS AND GENERAL PROVISIONS OF CONTRACT, INCLUDING GENERAL AND SUPPLEMENTARY CONDITIONS AND REQUIREMENTS OF DIVISION 1 SPECIFICATIONS APPLY TO WORK OF THIS SECTION.

1.03 QUALITY ASSURANCE

- THE TREE SALVAGE CONTRACTOR SHALL HAVE A MINIMUM OF FIVE (5) YEARS EXPERIENCE IN TRANSPLANTING TREES SUCCESSFULLY. PROVIDE EVIDENCE THAT THEY HAVE BEEN HARVESTED. TREES FOUND TO HAVE PESTS OR DISEASE SHALL BE TREATED PRIOR TO EXCAVATING ROOT BALL. FINE TREES SHALL BE TREATED WITH A PREVENTATIVE BORER INJECTION.

- THE TREE SALVAGE CONTRACTOR SHALL PROVIDE REFERENCES FROM AT LEAST TWO (2) PREVIOUS CLIENTS WHERE WORK SIMILAR IN SIZE AND SCOPE TO THIS PROJECT HAS BEEN COMPLETED. THE CONTRACTOR SHALL PROVIDE PHOTOGRAPHS OF VARIOUS STAGES OF WORK PROJECTS SIMILAR TO THIS.

- THE TREE SALVAGE CONTRACTOR SHALL PROVIDE A LIST OF COMPLETED PROJECTS INCLUDING REFERENCES AND PHOTOGRAPHS OF THE CURRENT CONDITIONS OF THE TREES ON AT LEAST TWO (2) PROJECTS.

- THE OWNER HAS PROVIDED A LIST OF THE EXISTING TREES AND PALMS INCLUDED WITHIN THIS SCOPE OF WORK. IT SHALL BE THE TREE SALVAGE CONTRACTOR'S RESPONSIBILITY TO NOTIFY THE OWNER OF ANY DISCREPANCIES BETWEEN THE LISTS AND KNOWN CONDITIONS IN THE FIELD.

- THE TREE SALVAGE CONTRACTOR SHALL EMPLOY A CERTIFIED LANDSCAPE ARCHITECT WHO SHALL BE RESPONSIBLE FOR THE INSPECTION OF THE TREES AND PALMS PRIOR TO HARVESTING, REVIEW OF THE TREES AND PALMS DURING HARVESTING AND TRANSPORTING AND PERIODIC ASSESSMENTS OF THE TREES AND PALMS IN THE HOLDING NURSERY. THE ARCHITECT SHALL BE RESPONSIBLE TO MAINTAIN THE DATABASE AS SPECIFIED IN 3.05 C, BELOW.

1.04 JOB CONDITIONS

- PROTECTION:

- PROTECT THE OWNER'S PROPERTY FROM INJURY OR LOSS, ANY DAMAGE TO EXISTING PROPERTY (BUILDINGS, UTILITIES, ETC.) OR PLANTING (TREES, SHRUBS, LAWN OR GROUND COVER CAUSED BY THE TREE SALVAGE CONTRACTOR DURING HIS OPERATION SHALL BE REPAIRED AT THE CONTRACTOR'S EXPENSE.

- CAUSE MINIMUM INTERFERENCE WITH WORKMEN, MATERIALS, OR OTHER EQUIPMENT OF OTHER TRADES ON THE PROJECT.

- LANDSCAPE WORK SHALL NOT BEGIN UNTIL ALL CONSTRUCTION ADJACENT TO THE PLANTING AREAS HAS BEEN COMPLETED UNLESS OTHERWISE DIRECTED BY OWNER OR GENERAL CONTRACTOR. (GENERAL CONTRACTOR WILL PROVIDE A DETAILED SCHEDULE TO SUCCESSFUL BIDDER).

- INSPECTION OF SITE:

- THE TREE SALVAGE CONTRACTOR SHALL BE REQUIRED TO VISIT THE SITE IN ORDER TO FAMILIARIZE HIMSELF WITH THE EXISTING CONDITIONS, INCLUDING BUT NOT LIMITED TO SOIL, DRAINAGE, TOPOGRAPHY, EXISTING STRUCTURES, TOWERS, POLES, OVERHEAD AND UNDERGROUND UTILITIES AND SERVICES.

- IF THE CONTRACTOR FINDS ANY SITE CONDITION AT VARIANCE WITH THE PLANS OR SPECIFICATIONS, HE SHALL NOTIFY THE LANDSCAPE ARCHITECT AND OWNER AND OBTAIN CLARIFICATION.

- THE TREE SALVAGE CONTRACTOR SHALL REVIEW THE CONDITION OF EACH TREE AND PALM TO BE RELOCATED PRIOR TO PREPARING THE TREE OR PALM FOR REMOVAL. THE CONTRACTOR SHALL NOTIFY THE OWNER AND LANDSCAPE ARCHITECT IF IN THEIR OPINION ANY TREE OR PALM IS NOT ACCEPTABLE FOR RELOCATION.

- THE TREE SALVAGE CONTRACTOR SHALL REVIEW THE CONDITION OF EACH TREE AND PALM TO BE RELOCATED PRIOR TO PREPARING THE TREE OR PALM FOR REMOVAL. THE CONTRACTOR SHALL NOTIFY THE OWNER AND LANDSCAPE ARCHITECT IF IN THEIR OPINION ANY TREE OR PALM IS NOT ACCEPTABLE FOR RELOCATION.

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- LAYOUT OF NURSERY: TREES SHOULD BE GROUPED BY VARIETY AND SIZE AND ALLOW ACCESS TO EACH GROUP. PALMS SHOULD BE GROUPED BY VARIETY AND HEIGHT AND ALLOW ACCESS TO EACH GROUP.
- LAYOUT OF AUTOMATIC IRRIGATION SYSTEM. THE OWNER WILL PROVIDE A POINT OF CONNECTION FOR WATER AND ELECTRIC POWER.
- PROGRAM FOR MAINTENANCE AND PROTECTION OF THE TREES AND PALMS INCLUDING PRUNING, WEED CONTROL, WATERING, FERTILIZATION, GUYING (WIND PROTECTION), INSECT AND DISEASE CONTROL, PROTECTION FENCING ETCETERA.
- AMOUNT OF AREA REQUIRED FOR THE NURSERY AND ANY OTHER FACILITIES OR INFRASTRUCTURE SUPPLIED BY THE CONTRACTOR OR REQUIRED OF THE OWNER.
- PROPOSED METHOD FOR STOKING THE TREES AND PALMS BASED ON THE TYPE OF ROOTBALL METHOD OF HARVESTING.

- THE TREE SALVAGE CONTRACTOR SHALL BE REQUIRED TO MAINTAIN A DATABASE ON ALL TREES AND PALMS INCLUDED WITHIN THIS PROJECT. INFORMATION REQUIRED TO BE MAINTAINED SHALL INCLUDE, BUT IS NOT LIMITED TO:

- TREE OR PALM TAG NUMBER, VARIETY AND SIZE
- TASK PERFORMED AND DATE
- DATE AND METHOD OF HARVESTING AND ROOTBALL SIZE
- LOCATION IN NURSERY
- MAINTENANCE PERFORMED AND DATE

PART 2 - PRODUCTS

2.01 GENERAL

- IT IS THE INTENT OF THIS SPECIFICATION THAT ALL MATERIALS HEREIN SPECIFIED AND SHOWN ON THE DRAWINGS SHALL BE OF THE HIGHEST QUALITY AVAILABLE AND MEET THE REQUIREMENTS SPECIFIED.

2.02 MISCELLANEOUS MATERIALS

- PALM FERTILIZER SHALL BE "MACON PALM SAVOR" AVAILABLE FROM WWW.PLANTEALTHECARE.COM OR APPROVED EQUIVALENT.
- TREE FERTILIZER SHALL BE DR. BENSON'S NATURAL MIX AVAILABLE FROM WWW.DRENSONSNATURALMIX.COM (OR APPROVED EQUIVALENT).

PART 3 - EXECUTION

3.01 PREPARATION OF TREES

- PRIOR TO HARVESTING TREES FROM THEIR EXISTING LOCATION THEY SHALL BE PREPARED UTILIZING THE FOLLOWING TREATMENTS AND OR PROCEDURES:

- PRUNING - REMOVE ANY DEAD OR DAMAGED BRANCHES AND SHALL COMPLY WITH THE "AMERICAN NATIONAL STANDARD INSTITUTE (ANSI), A302-1995", CURRENT EDITION RESPECTIVELY. THIN OUT OVERALL CANOPY OF TREES TO COMPENSATE FOR REDUCTION OF ROOT SYSTEM. PRUNING SHALL BE REQUIRED TO ALLOW ACCESS TO ROOT BALL AND TRANSPORTING.

- ROOT PRUNING - DETERMINE SIZE OF ROOT BALL REQUIRED BASED ON DBH OF TREE ACCORDING TO ANSI AMERICAN STANDARD FOR NURSERY STOCK 2001-1999. ROOT BALLS SHALL BE DUG BY HAND EXCAVATION USING A SHARP SPade. TRENCING WITH A TRENCER OR BACKHOE IS NOT ACCEPTABLE. ROOT PRUNING SHALL BE DONE TO A MINIMUM DEPTH OF 30" USING HAND PRUNERS OR PRUNING SAW.

- WATERING - PRIOR TO ANY EXCAVATION, ALL TREES SHALL BE THOROUGHLY WATERED TO A MINIMUM DEPTH OF 30" AND BEYOND THE AREA OF THE ROOT BALL.

- INSPECTION OF TREES - ALL TREES SHALL BE INSPECTED BY THE SALVAGE CONTRACTORS AND/OR PRIOR TO EXCAVATING ROOT BALLS. ANY FINDINGS OF INSECTS, DISEASE OR STRUCTURAL DAMAGE SHALL BE NOTED IN THE TREE DATABASE. INSECTS OR DISEASE SHALL BE REMEDIATED PRIOR TO EXCAVATING ROOT BALLS AS WELL AS SUPPORTING OR CORRECTING ANY STRUCTURAL PROBLEMS.

- CHEMICAL TREATMENT - ALL TREES SHALL BE INOCULATED WITH MYCORRHIZAL FUNGI THAT HAVE BEEN HARVESTED. TREES FOUND TO HAVE PESTS OR DISEASE SHALL BE TREATED PRIOR TO EXCAVATING ROOT BALL. FINE TREES SHALL BE TREATED WITH A PREVENTATIVE BORER INJECTION.

- ROOT BALLS SHALL BE MINIMUM 3" DEEP. PROTECT ROOT BALLS WITH WOOD BOXES. ROOT BALLS 10 FT. AND LARGER SHALL BE STRUCTURAL. BOTTOM INSIDE ROOT BALL PRIOR TO BEING LIFTED FROM THE HOLE.

- EXISTING TREES TO BE BARRICADED PRIOR TO BEGINNING OF CONSTRUCTION SHALL REMAIN IN PLACE DURING CONSTRUCTION, AS PER CITY OF HOLLYWOOD.

- NO HEAVY EQUIPMENT, CONSTRUCTION MATERIALS OR SOIL DEPOSITS ARE TO BE ALLOWED INSIDE TREE BARRIERS.

- TREE REMOVAL PERMIT SHALL BE REQUIRED PRIOR TO CONSTRUCTION AND ANY CLEARING OPERATIONS AS REQUIRED.

3.02 TRANSPORTING AND HANDLING OF TREES

- THE FOLLOWING GUIDELINES APPLY TO TRANSPORTING TREES DURING THE SALVAGE AND STORAGE OPERATION:

- EMPLOY METHODS THAT ASSURE THAT THE ROOTBALLS ARE PROTECTED WHILE BEING HANDLED, TRANSPORTED OR STORED. ROOTBALLS SHALL REMAIN IN FACT AND STRUCTURALLY SOUND.

- TREES HARVESTED UTILIZING WOOD BOXES SHALL BE RIGGED PRIMARILY BY THE BOX. FOR ANY SALVAGED TREE, ANY SUPPORT RIGGING THAT COMES IN CONTACT WITH THE TREE SHALL BE NYLON STRAP; NO CABLE OR CHAINS SHALL BE USED.

- TREE BRACING AND LIMBS SHALL BE PROTECTED DURING HANDLING, TRANSPORTING OR STORAGE. INITIAL CABLEING AS REQUIRED TO SUPPORT BRANCHING STRUCTURE.

- ANY TREES THAT ARE SEVERELY DAMAGED OR DIE DURING HARVESTING, TRANSPORTING OR STORAGE SHALL BE REPLACED AS NOTED UNDER SECTION 3.10 GUARANTEE AND REPLACEMENT.

- TREES IN THE STORAGE AREA SHALL BE GUYED AND OR BRACED BY THE SALVAGE CONTRACTOR AS REQUIRED TO MAINTAIN TREES UPRIGHT.

3.03 PREPARATION OF PALM TREES

- PRIOR TO HARVESTING PALMS FROM THEIR EXISTING LOCATION THEY SHALL BE PREPARED UTILIZING THE FOLLOWING TREATMENTS AND OR PROCEDURES:

A. PRUNING PROCEDURE:

- WHEN HARVESTING MEXICAN FAN, TEXAS PALMETO AND OTHER FAN PALMS FROM THEIR EXISTING LOCATION, PALME THE FRONTS AS FOLLOWS:

- WITH THE USE OF HAND LOPPERS AND HAND PRUNING SAWS, 30% MAXIMUM OF PALM FRONTS SHALL BE REMOVED DURING THE EXCAVATION PERIOD. NO TREE SHOULD HAVE ANY FROND CUT HIGHER THAN 30 DEGREES ABOVE PARALLEL TO THE GROUND (MAXIMUM). A MINIMUM OF THREE (3) FRONDS OF FRONDS BELOW THE CLOROX INFILTRATION. FRUIT/FLOWER POSITION SHALL REMAIN ON THE TREE. REMOVAL OF RANDOM FRONDS TO FACILITATE CROWN TYING IS UNACCEPTABLE. FRONDS FROM PROXIMITY GROWING PALMS SHALL BE REMOVED AFTER PALMS ARE APPROVED AND CERTIFIED TO BE FREE OF DISEASE BY THE FRUIT/LOST. ALL PALM FRONDS SHALL BE TIED IN AN UPRIGHT POSITION WITH 2-PLY TWINE. TWINE SHALL BE TIED HORIZONTALLY ACROSS PALM FRONDS. TWINE IS TO BE APPLIED TIGHT ENOUGH TO REMAIN TIED DURING ALL TRANSPORTING AND PLANTING PHASES OF WORK. PRUNING TOOLS (INCLUDING, BUT NOT LIMITED TO, CHAINSAWS, LOPPERS, PRUNING SAWS, SHOVELS, GLOVES) SHALL BE STERILIZED WITH A SOLUTION OF 50% WATER AND 50% BLEACH BETWEEN EACH PALM. IMMEDIATE CUTTING SURFACES IN THE CLOROX SOLUTION AND AGITATE AFTER IMMERSION. RINSE TOOL WITH WATER THOROUGHLY. NO PALMS WITH CLIPPED FROND TIPS WILL BE ACCEPTED. REMOVE ANY FRUIT/FLOWER STEMS EXISTING ON THE PALM.

- WHEN HARVESTING COCONUT, CANARY ISLAND, DATE AND OTHER FEATHER PALMS FROM THEIR EXISTING LOCATION, PRUNE THE FRONDS AS FOLLOWS:

- WITH THE USE OF HAND LOPPERS AND HAND PRUNING SAWS, 30% MAXIMUM OF PALM FRONDS SHALL BE REMOVED DURING THE EXCAVATION PERIOD. NO TREE SHOULD HAVE ANY FROND CUT HIGHER THAN 30 DEGREES ABOVE PARALLEL TO THE GROUND (MAXIMUM). A MINIMUM OF THREE (3) FRONDS OF FRONDS BELOW THE CLOROX INFILTRATION. FRUIT/FLOWER POSITION SHALL REMAIN ON THE TREE. REMOVAL OF RANDOM FRONDS TO FACILITATE CROWN TYING IS UNACCEPTABLE. FRONDS FROM PROXIMITY GROWING PALMS SHALL BE REMOVED AFTER PALMS ARE APPROVED AND CERTIFIED TO BE FREE OF DISEASE BY THE FRUIT/LOST. ALL PALM FRONDS SHALL BE TIED IN AN UPRIGHT POSITION WITH 2-PLY TWINE. TWINE SHALL BE TIED HORIZONTALLY ACROSS PALM FRONDS. TWINE IS TO BE APPLIED TIGHT ENOUGH TO REMAIN TIED DURING ALL TRANSPORTING AND PLANTING PHASES OF WORK. PRUNING TOOLS (INCLUDING, BUT NOT LIMITED TO, CHAINSAWS, LOPPERS, PRUNING SAWS, SHOVELS, GLOVES) SHALL BE STERILIZED WITH A SOLUTION OF 50% WATER AND 50% BLEACH BETWEEN EACH PALM. IMMEDIATE CUTTING SURFACES IN THE CLOROX SOLUTION AND AGITATE AFTER IMMERSION. RINSE TOOL WITH WATER THOROUGHLY. NO PALMS WITH CLIPPED FROND TIPS WILL BE ACCEPTED. REMOVE ANY FRUIT/FLOWER STEMS EXISTING ON THE PALM.

B. PALM TRUNKS:

- THE TRUNKS OF TEXAS PALMETO AND MEXICAN FAN PALMS SHALL BE CLEAN AND SKINNED TO WITHIN 6" OF HEART LEAF.
- THE TRUNKS OF DATE PALMS SHALL BE CLEANED. REMOVE REMNANT PETIOLE BOOTS FROM THE TRUNK TO WITHIN 4" OF THE HEART LEAF. THE PALM TRUNKS SHALL BE TRIMMED TO WITHIN 4" OF REMAINING AT THE TOP OF TRUNK SHALL BE TRIMMED IN ORDER THAT THEY ARE UNIFORM IN LENGTH AND APPEARANCE.

- THE TRUNKS OF CANARY ISLAND DATE PALMS SHALL BE CLEANED. REMOVE REMNANT PETIOLE BOOTS FROM THE TRUNK TO WITHIN 4" OF THE HEART LEAF. THE PALM TRUNKS SHALL BE TRIMMED TO WITHIN 4" OF REMAINING AT THE TOP OF TRUNK SHALL BE TRIMMED IN ORDER THAT THEY ARE UNIFORM IN LENGTH AND APPEARANCE.

C. ROOTBALL REQUIREMENTS:

- REQUIREMENTS FOR TEXAS PALMETO, MEXICAN FAN AND OTHER FAN PALM ROOTBALLS:




- MINIMUM ROOTBALL SIZE:



- 10'-15" BROWN TRUNK 2 1/2" CURED
- 15'-20" BROWN TRUNK 3" CURED
- 21'-30" BROWN TRUNK 4" CURED

- REQUIREMENTS FOR DATE PALM ROOTBALLS:

- MINIMUM ROOTBALL SIZE:

- 10'-20" BROWN TRUNK 4" X 4" X 5" DEEP
- 21'-25" BROWN TRUNK 6" X 6" X 5" DEEP
- 26'-30" BROWN TRUNK 8" X 6" X 4" X 5" DEEP
- 31'-35" BROWN TRUNK

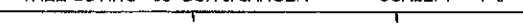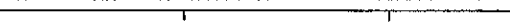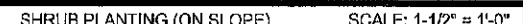

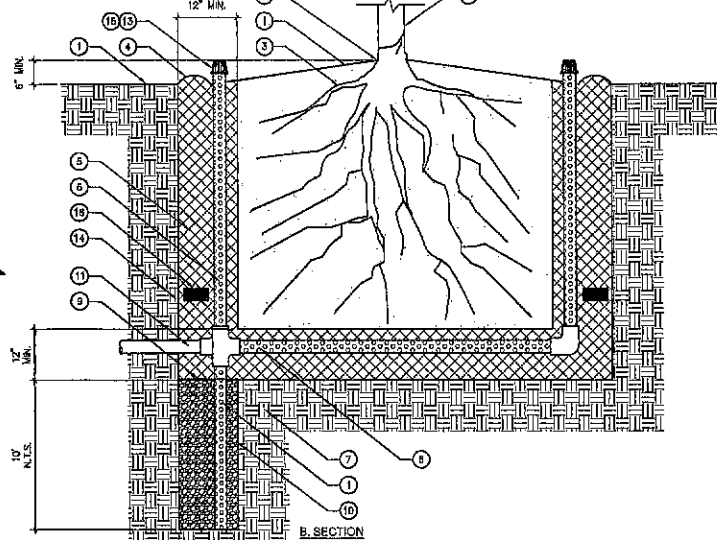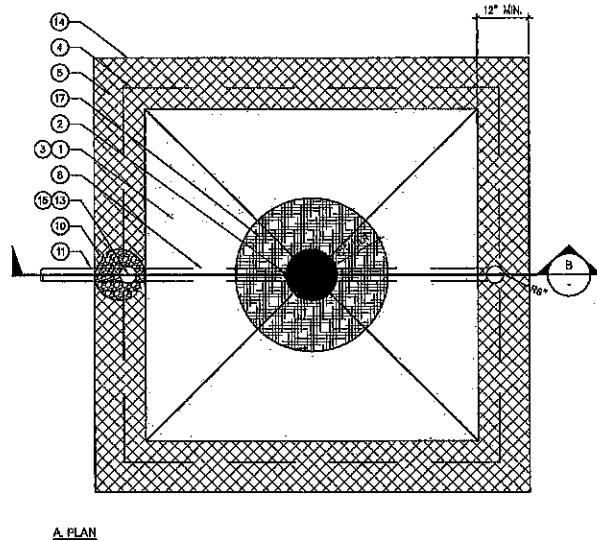

- 1 FINISH GRADE IN PLANTING AREA
- 2 TREE TRUNK
- 3 TREE ROOTBALL
- 4 BERM TO FORM WATERING BASIN ON TOP OF TREE ROOTBALL. REMOVE PRIOR TO END OF MAINTENANCE PERIOD.
- 5 PREPARED BACKFILL PLANTING MIX PER PLANTING SPECIFICATIONS
- 6 4" DIA. PERFORATED PIPE VERTICAL ON 2 SIDES OF TREE ROOTBALL, WRAPPED IN FILTER FABRIC
- 7 NATIVE SOIL
- 8 4" PERFORATED PIPE WRAPPED WITH FILTER FABRIC UNDER TREE ROOTBALL AND DOWN AUGERED HOLE
- 9 INSTALL FILTER FABRIC ON TOP OF AUGERED HOLE
- 10 12" DIA. X 16" DEEP AUGERED HOLE UNDER TREE PLANTING PIT. FILL WITH COURSE GRAVEL AND PERFORATED PIPE DOWN TO BOTTOM - MAX. 3 TREES CONNECTED TO ONE AUGERED HOLE
- 11 4" DIA. SOLID DRAIN PIPE TO ADJACENT TREE - MAX. 3 TREES CONNECTED TO ONE AUGERED HOLE
- 12 PLANT TREE IN ORDER THAT ROOTCROWN IS 9" ABOVE FINISH GRADE ADJACENT TO PLANTING PIT
- 13 INSTALL ATRIUM GRAVE (NOS 10) ON TOP OF VERTICAL PIPES (2 PLACES) FOR TREES IN PLANTING AREA. INSTALL FLAT GRAVE (NOS 13) ON TOP OF VERTICAL PIPES (2 PLACES) FOR TREES IN TURF AREAS.
- 14 SIDES OF PLANTING PIT'S SHALL BE MADE ROUGH
- 15 EXTEND FILTER FABRIC BEYOND TOP OF PIPE, TIE IN KNOT, PUSH KNOT INTO PIPE
- 16 PLANT FERTILIZER TABS - QUANTITY PER THE MANUFACTURER'S SPECIFICATIONS. PLACE TABS IN PLANT CONTAINER PRIOR TO PLANTING FOR REVIEW BY LANDSCAPE ARCHITECT.
- 17 TREE PLANTED IN TURF TO RECEIVE MULCH PER SPECIFICATION 12" CLR. FROM TRUNK

NOTES:
1. REFER TO GENERAL CONSTRUCTION NOTES - PLANTING NOTES, SHEET L6.01
2. REFER TO IRRIGATION PLANS FOR INFORMATION REGARDING DRIP IRRIGATION AT EACH TREE
3. PALMS WITH CLIPPED TIPS AND NOT PER TO WRITTEN SPECIFICATIONS SHALL NOT BE ACCEPTED AND SHALL BE REJECTED ON SITE. REPLACEMENT SHALL BE THE RESPONSIBILITY OF THE LANDSCAPE CONTRACTOR.

SCALE: 3/4" = 1'-0"


DETAIL TITLE

SCALE: 1" = 1'-0"

C

TREE PLANTING PIT

IRONSMITH
41-781 Corporate Way #3
Palm Desert, CA 92260
800.336.4786

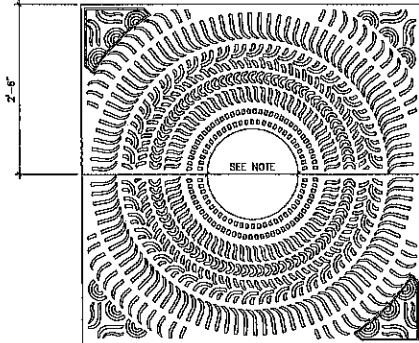

6014-2
CONQUISTADOR TREE
GRATE

60" X 60" TREE GRATE IN
TWO SECTIONS
TWO LIGHTWELLS WITH
WELDED COVER AS
SHOWN.

1/2" MAXIMUM SLOT
OPENING FOR
RESEAL RAIN SAFETY
AND ADA COMPLIANCE.

CAST FROM 100%
RECYCLED IRON,
ALUMINUM OR BRONZE
FOR PEDESTRIAN LOADS
ONLY.

TREE OPENING:
16" 20" 30"
GRATES CAN BE
ORDERED WITH OR
LATER EXPANDED TO
THESE OPENINGS.
PLEASE SPECIFY WHEN
ORDERING.

FINISH UNFINISHED OR
BLACK OIL OR
ENAMEL PAINT OR
POLYURETHANE PAINT
OR
POWDER COAT
SPECIFY FINISH AND
COLOR

USE FRAME MODEL:
600F

WEIGHT:
IRON: 514 LBS/24" HD
ALUMINUM: 171 LBS/24" HD

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OGRADE

SCALE: 1" = 1'-0"


DETAIL TITLE

SCALE: 1" = 1'-0"

F

TREE GRATE (SUBJECT TO CHANGE IN WORKING DWGS.) SCALE: 1" = 1'-0"

C

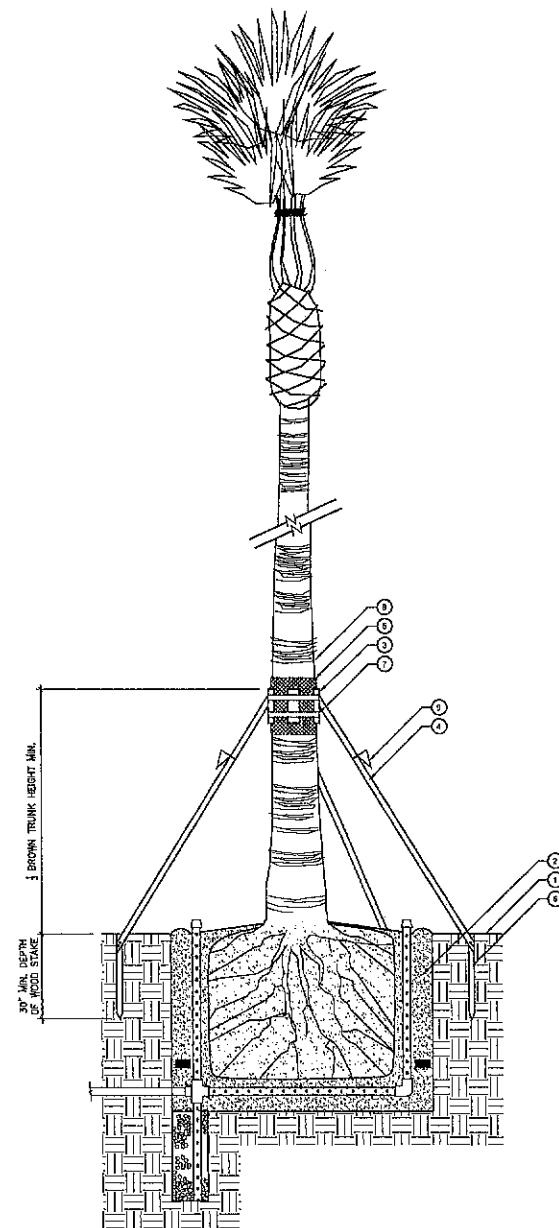

- 1 FINISHED GRADE OF PLANTING AREA
- 2 PALM TREE PLANTING PIT - REFER TO DETAIL 1" SHEET L6.01
- 3 2" X 4" X 12" WOOD BATTEN/CLAT SECURED AT TWO POINTS TO THE PALM AT A POINT EQUAL TO 1/3 OF THE BROWN TRUNK HEIGHT OF THE PALM
- 4 2" X 4" WOOD BRACES (MIN. OF 3 TOTAL) SPACED AT 120 DEGREES APART OR EQUALLY AROUND TREE TRUNK. SAW CUT ENDS AT PROPER ANGLE TO ALLOW FOR FLUSH CONNECTION TO WOOD BATTEN/CLAT. NAIL WOOD BRACES SECURELY TO WOOD BATTEN/CLAT
- 5 WRAP THE TRUNK WITH A 16" WIDE MIN. PIECE OF DURLAP (3) LAYERS THICK AIN TO PREVENT BRACING BOARD CLIENTS FROM CHIPPING THE BARK
- 6 2" X 4" WOOD STAKE, WITH BOARDS POSITIONED FACES TO FACE, NAIL BRACE SECURELY TO WOOD STAKE BELOW FINISH GRADE
- 7 BANDS OR STRAPS
- 8 PALM TREE TRUNK
- 9 SAFETY FLAGS

SCALE: 1/2" = 1'-0"

DETAIL TITLE

SCALE: 1" = 1'-0"

J

DETAIL TITLE


SCALE: 1" = 1'-0"

I

PALM TREE STAKING

SCALE: 1" = 1'-0"

B

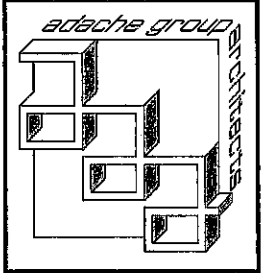

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HOLLYWOOD BEACH, FLORIDA

SEAL:

ISSUED FOR: TAC REVIEW

DATE: 9/3/2010

REVISIONS:

No. DATE REMARKS

SHEET TITLE:

LANDSCAPE

PLANT MATERIAL DETAILS

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EVIDENCE OF ACCEPTANCE OF THESE RESTRICTIONS.

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FLORIDA LICENSE # AR0007073

DATE: 9/3/2010

SCALE: AS NOTED

DRAWN BY: MM

CHECKED BY: DA

JOB NO.: 10046

SHEET NO.:

L2.03

Attachment B


Margaritaville Signage

**Sign Variance Criteria Statement
For
Margaritaville Hollywood Beach Resort**


a. **The variance is not contrary to the public interest.** The Applicant is seeking a variance to waive the signage regulations set forth within Section 8.5(b)(9) of the City's Zoning and Land Development Regulations which govern sign size, number and height within the Johnson Street property zoned "GU" (Government Use). In lieu of same, the Applicant is proposing a signage program specifically designed for the Margaritaville Hollywood Beach Resort, as set forth within the proposed site plans under review, so that all proposed signage will be architecturally and aesthetically compatible with the buildings that they are placed upon. A cohesive and comprehensive signage program will work to strengthen the design and overall public image that Margaritaville conveys to prospective guests and the public. As a key component of the development's signature design and architectural elements, the signage program also serves to efficiently convey appropriate information about each aspect of the resort, spa and entertainment complex, and in no way serves to act in contrast to public interest.

b. **The variance is required due to special conditions.** As part of the City's desire to develop the Johnson Street location into a world class hotel resort, spa and public entertainment hub and parking facility, the Applicant has diligently worked with the City to accomplish this task by designing the proposed Margaritaville Hollywood Beach Resort. Given the size, importance and purpose of the project, the Applicant is seeking this variance as part of an overall plan to create a world-renowned destination resort to draw both city residents and guests alike to visit and enjoy Hollywood Beach. The resort serves to not only drive the economic engine necessary to revitalize Hollywood Beach, but also to provide an entertainment facility open for the public to use and enjoy. It is based upon these special conditions that the Applicant is requesting this variance, as it is critical that the development create presence and an identity through the use of easily recognizable signage consistent with the architectural and design elements of the resort.

c. **A literal enforcement of the provisions of Article 8 may result in an unnecessary hardship.** From a branding and promotional standpoint, it is crucial that Margaritaville's proposed signage creates an easily recognizable image and identity tied into the "Margaritaville" lifestyle which encourages the public to experience the resort, spa and entertainment complex. The proposed signage program gives the resort "presence" no matter what direction you approach the resort from—a key aspect of fostering interest in the resort and driving business to the beach. Under the City's Zoning and Land Development Regulations, the existing signage regulations arguably did not contemplate the use of GU-zoned property for the development of a world-class hotel and public entertainment facility which have special architectural design elements associated with it. As such, if the existing signage regulations were literally enforced, Margaritaville's design cohesiveness, image, and most importantly, presence on Hollywood Beach would be diminished (particularly when compared with other resorts of similar scope and importance) thereby creating an economic hardship to the Applicant.

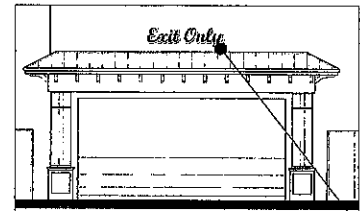

14 PARKING EXIT
1/8" = 1'-0"

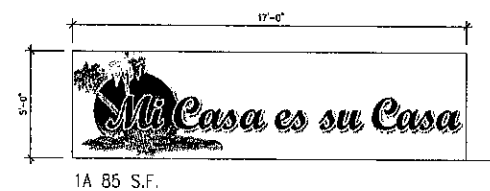


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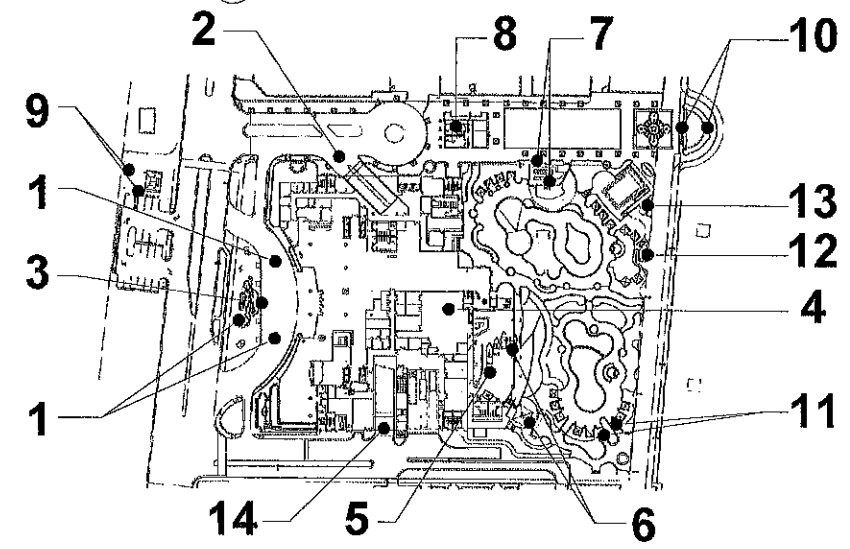
26 S.F.



230 S.F.



2 HOTEL NORTH ELEVATION SIGN
SCALE: 1/8" = 1'-0"

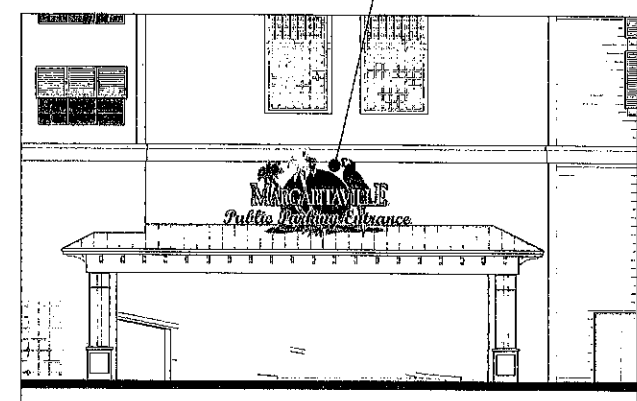

SIGNAGE, OUTBLDG. LOCATION MAP
N.T.S.



1 PORTE COCHERE
1/8" = 1'-0"




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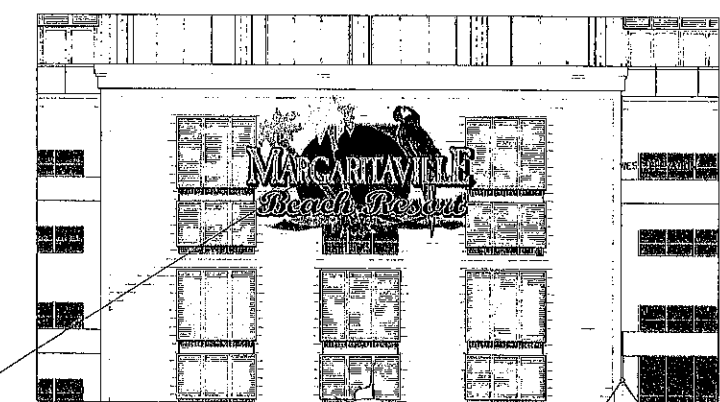
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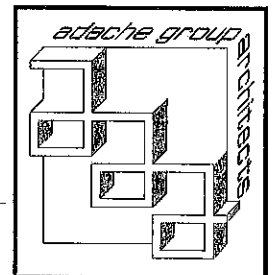
1B 48 S.F.



3 HOTEL WEST ELEVATION SIGN
SCALE: 1/8" = 1'-0"



4 HOTEL EAST ELEVATION SIGN
SCALE: 1/8" = 1'-0"

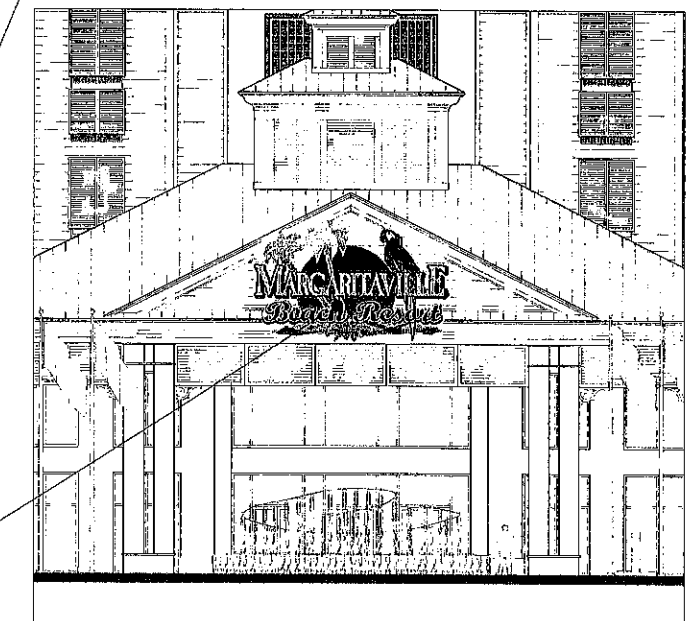

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SEAL:

ISSUED FOR: TAC FINAL
DATE: 10/29/2010


REVISIONS:		
No.	DATE	REMARKS

SHEET TITLE:
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PLANS AND ELEVATIONS


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DRAWN BY: JR
CHECKED BY: JB
JOB NO.: 94.08A


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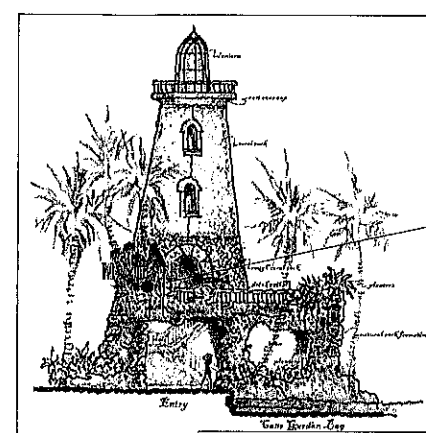
MARGARITAVILLE RESTAURANT SECOND FLOOR
SCALE: 3/32"=1'-0"

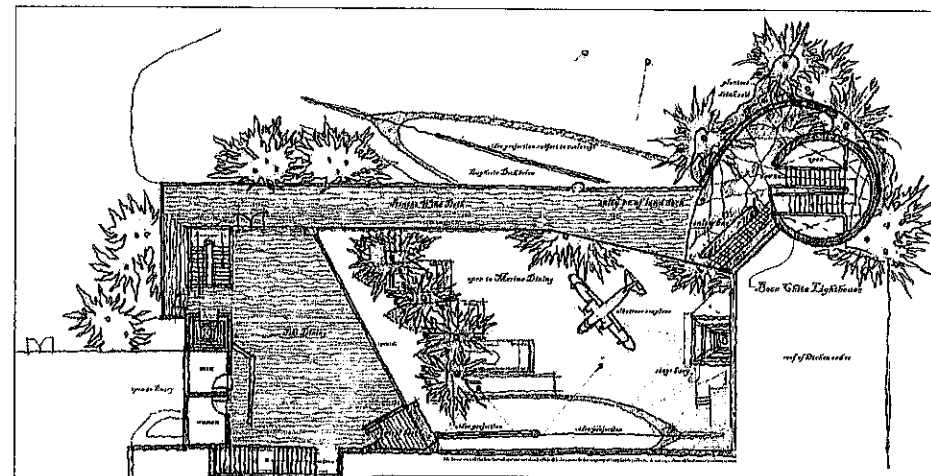

MARGARITAVILLE RESTAURANT FIRST FLOOR
SCALE: 3/32"=1'-0"

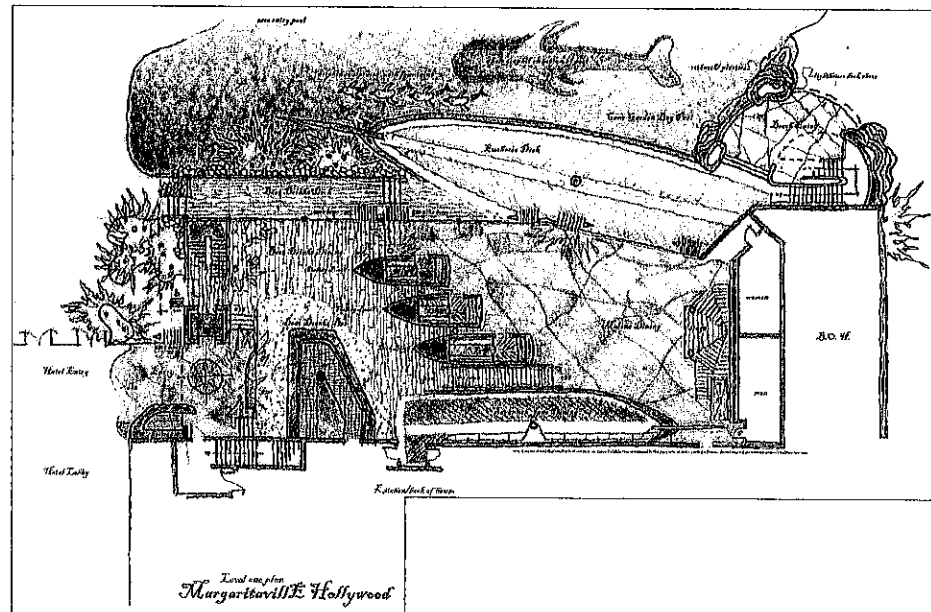


SIGNAGE, OUTBLDG. LOCATION MAP
N.T.S.

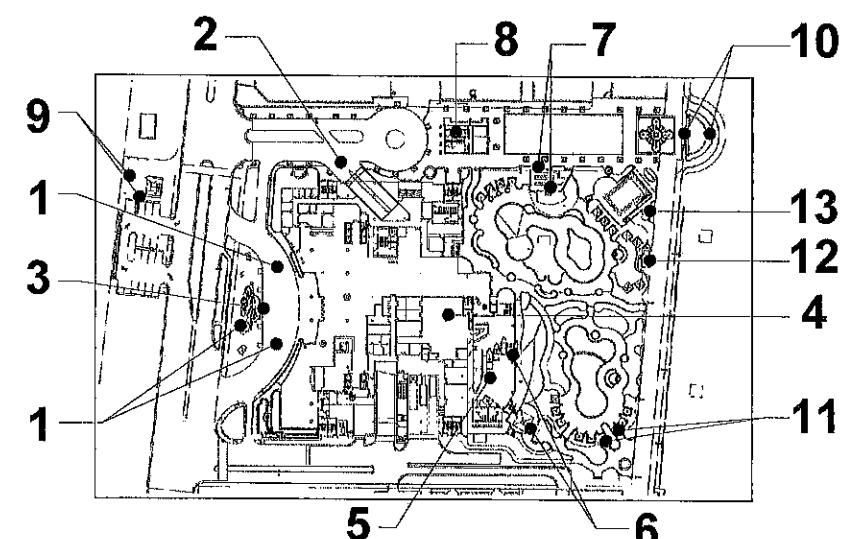


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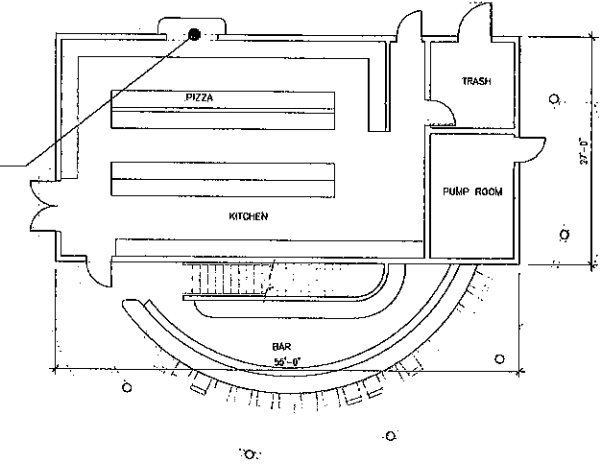
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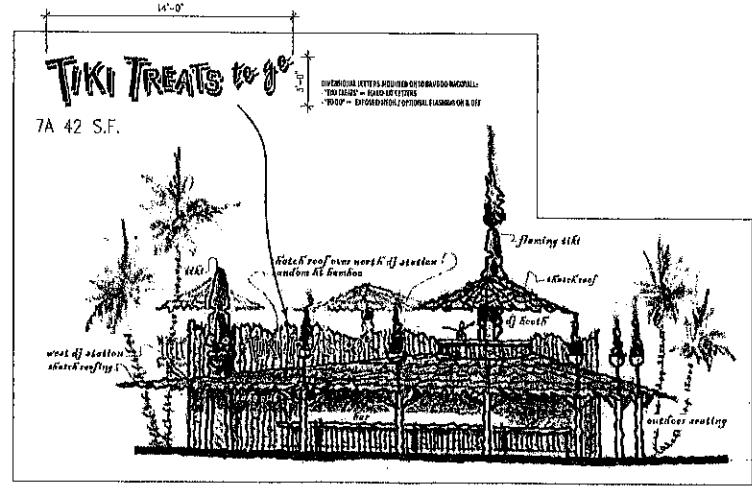
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SCALE: 3/32"=1'-0"




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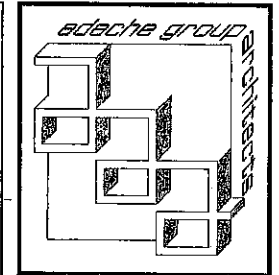
TIKI TREAT/PIZZA SHACK 1ST FL PLAN
SCALE: 1/8"=1'-0"

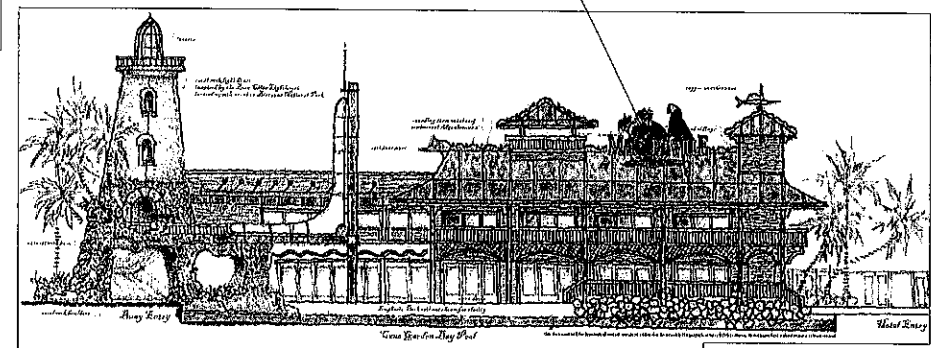

TIKI TREATS/PIZZA SHACK ELEVATION
SCALE: 1/8"=1'-0"

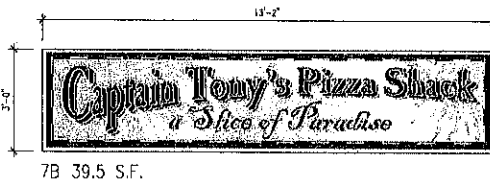

TIKI TREAT/PIZZA SHACK 2ND FL PLAN
SCALE: 1/8"=1'-0"

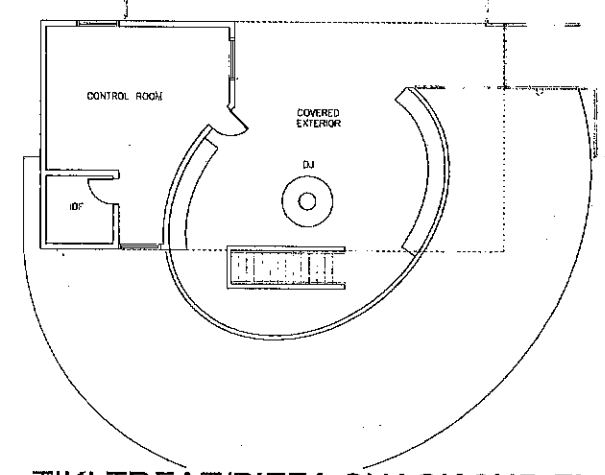

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ISSUED FOR: TAC FINAL
DATE: 10/29/2010


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No.	DATE	REMARKS

SHEET TITLE:
SIGNAGE, OUTBLDG. PLANS AND ELEVATIONS


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JOB NO.: 04.08A


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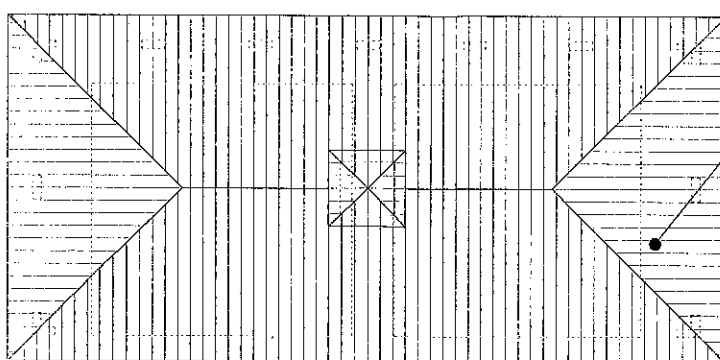
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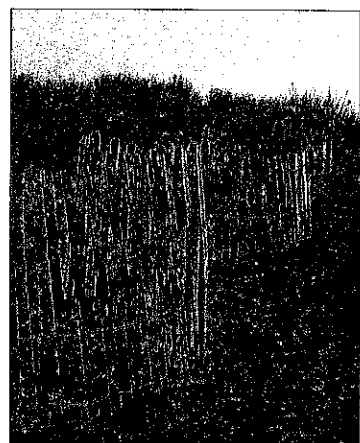
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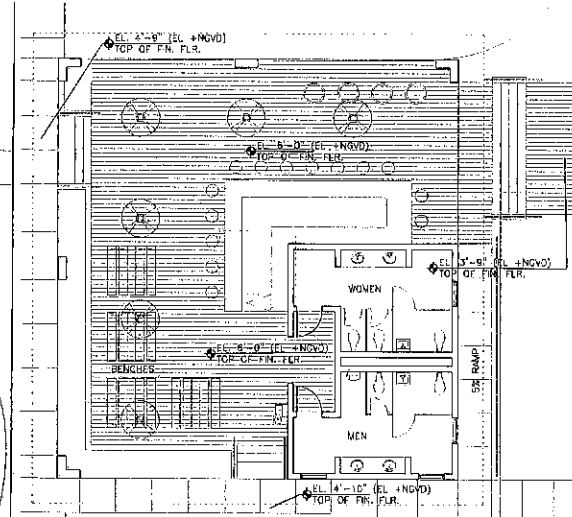
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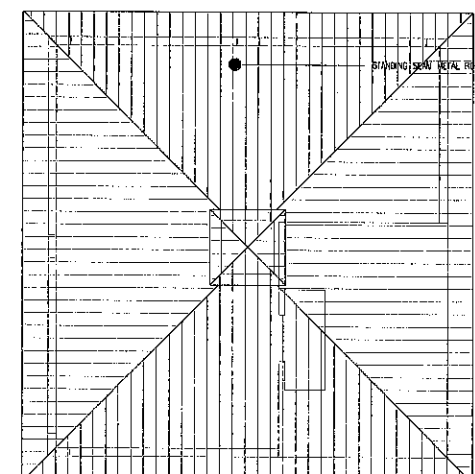
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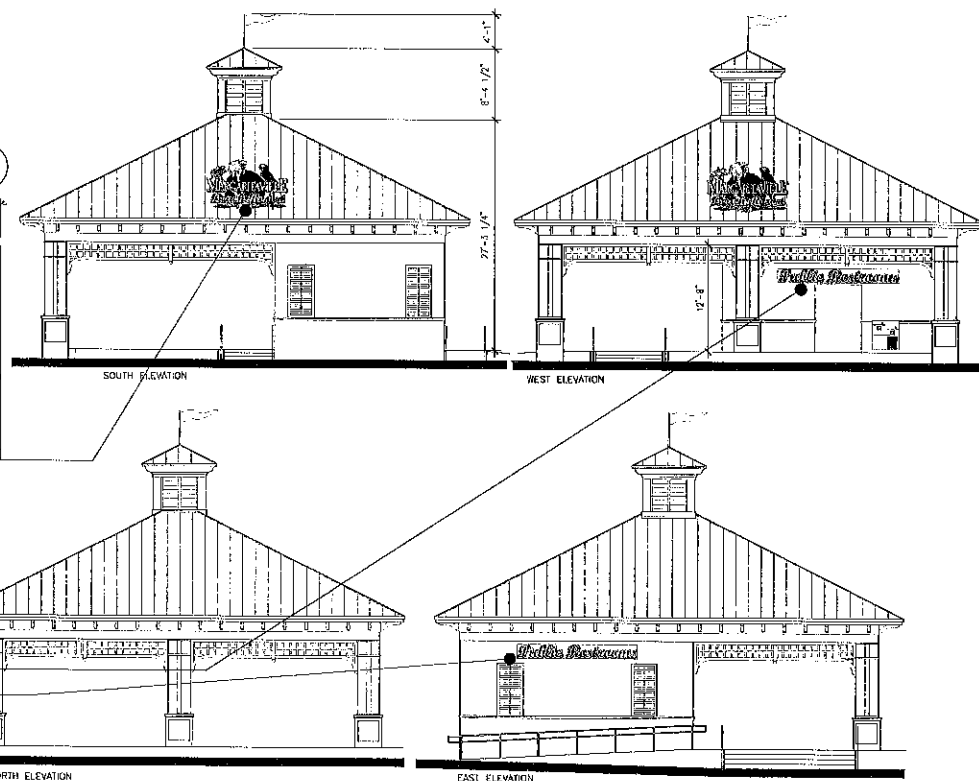
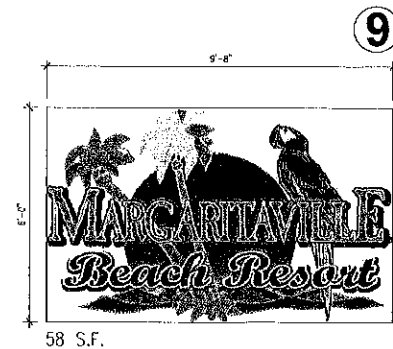
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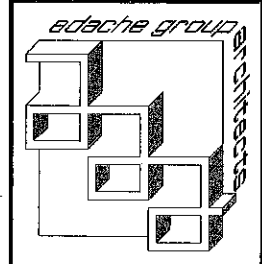
"THE DOCK"/RESTROOMS
SCALE: 1/8"=1'-0"

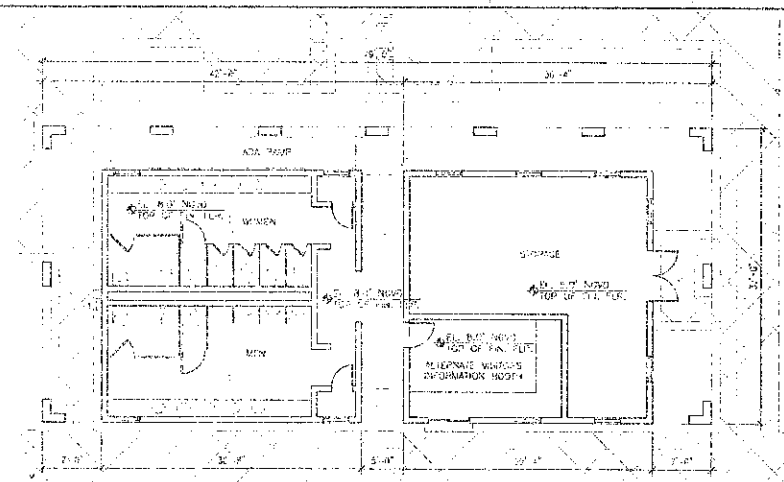

"THE DOCK"/RESTROOM ROOF PL.
SCALE: 1/8"=1'-0"

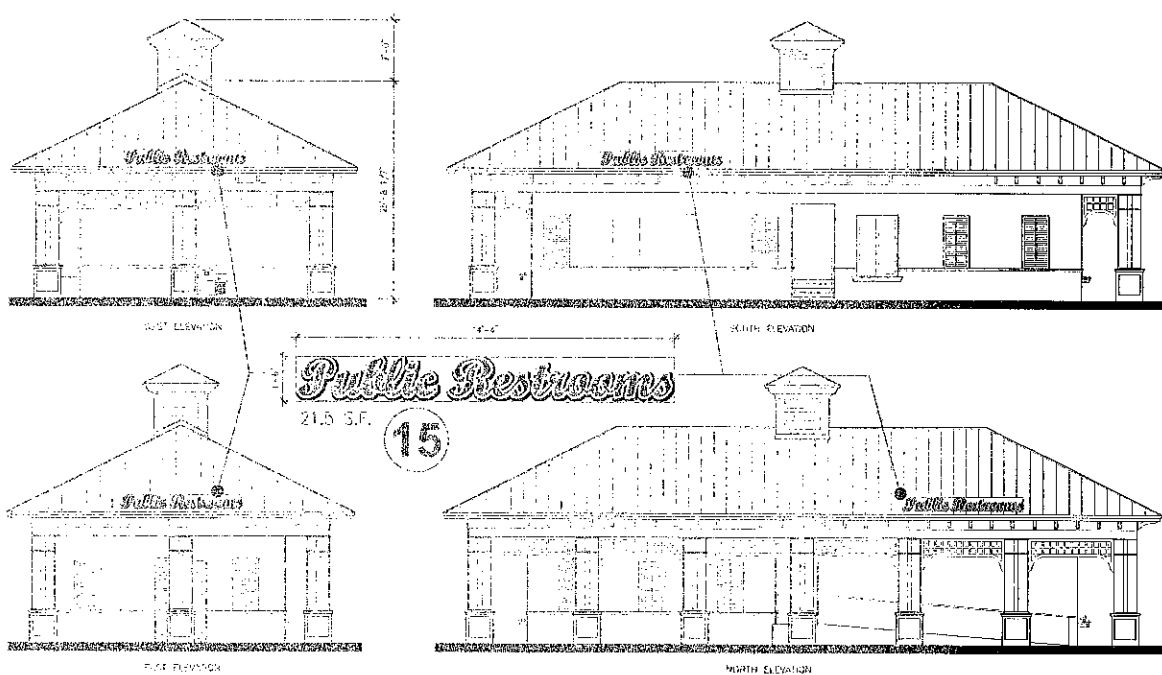

"THE DOCK"/RESTROOM ELEVATIONS
SCALE: 1/8"=1'-0"

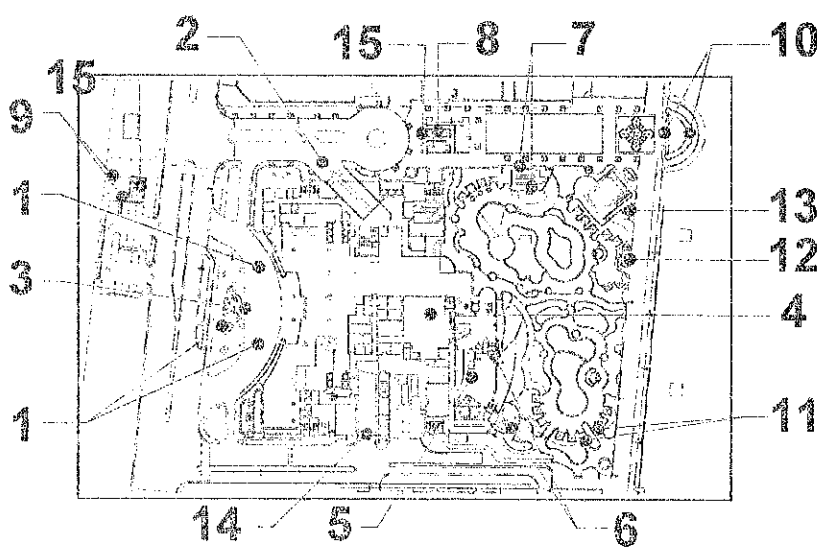

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SEAL:

ISSUED FOR: TAG FINAL
DATE: 10/23/2010




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No.	DATE	REMARKS

SHEET TITLE:
SIGNAGE, OUTBUILDING
PLANS AND ELEVATIONS



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DATE: _____
SCALE: _____
DRAWN BY: JR
CHECKED BY: JB
JOB NO.: 94.00A



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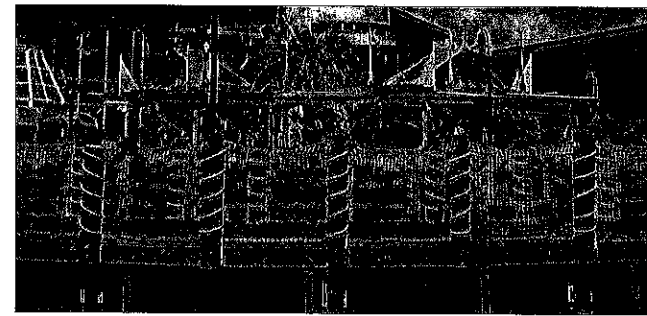
10 EXISTING BANDSHELL

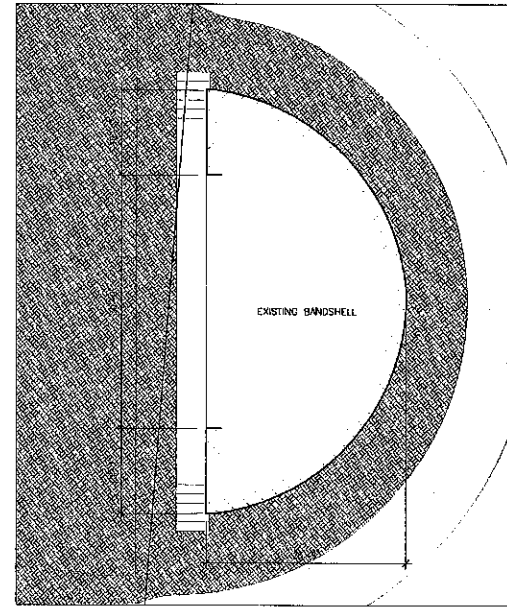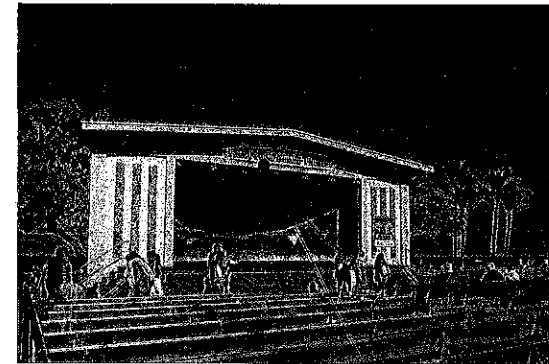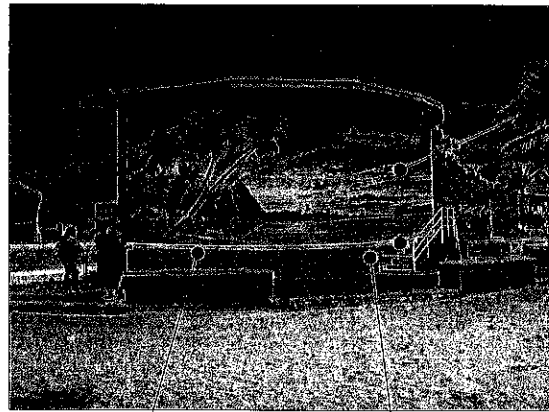


SIGNAGE, OUTBLDG. LOCATION MAP
N.T.S.

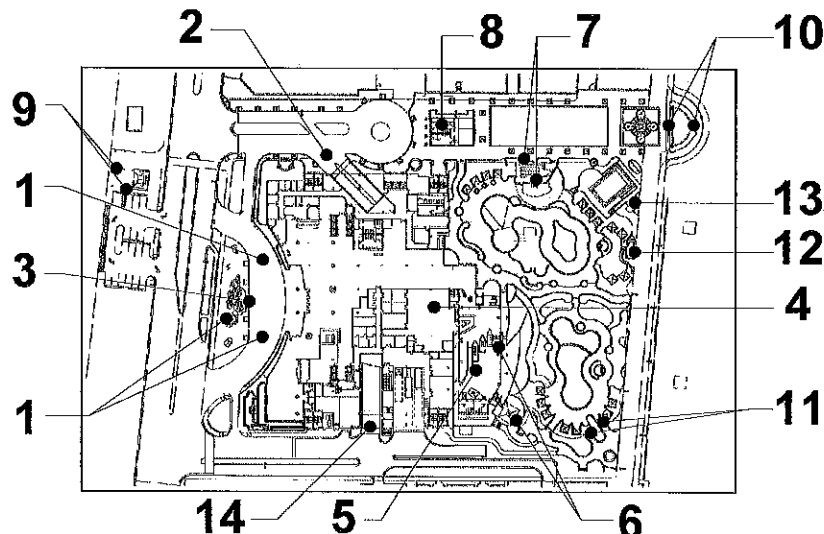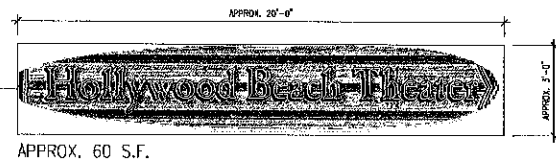


13 RIDIN' IN STYLE

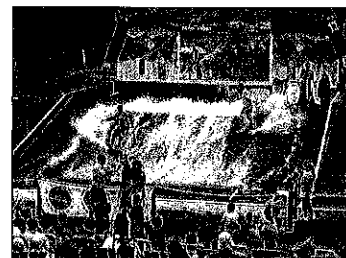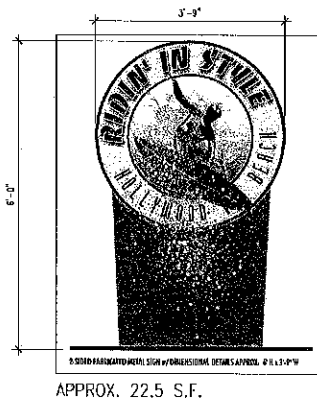

FISH NET FENCING

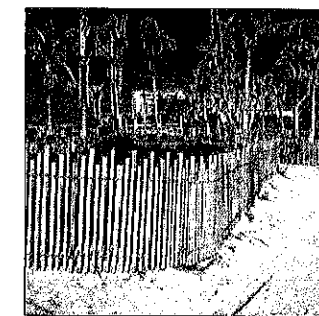

BAMBOO FENCING

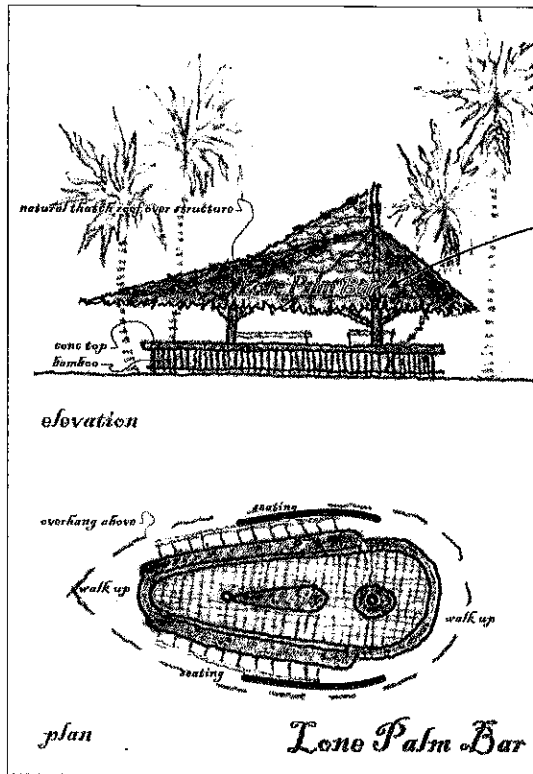


11 LONE PALM BAR
SCALE: 1/8"=1'-0"


FABRICATED CHANNEL LETTERS WITH EXPOSED REIN, MOUNTED ON ROOF / TOTAL OF TWO SIGNS ON ROOF
APPROX. 1'-0" W x 11'-0" L



FISH NET FENCING

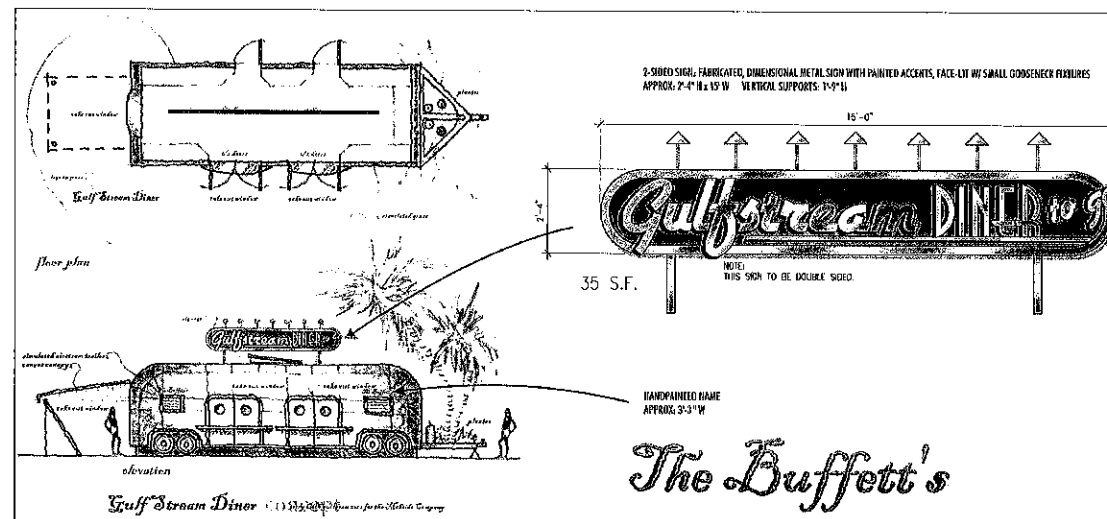

12 AIRSTREAM DINER
SCALE: 1/8"=1'-0"

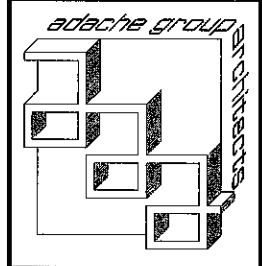

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1500 NICHOLL DRIVE, SUITE 100
MIAMI, FLORIDA 33194
PHONE: 376-5055 FAX: 305-278-4555

OWNER:
MARGARITAVILLE HOLLYWOOD
BEACH RESORT, LLC
3601 N. OCEAN DRIVE
HOLLYWOOD, FLORIDA 33019



SEAL:
ISSUED FOR: TAC FINAL
DATE: 10/29/2010

REVISIONS:		
No.	DATE	REMARKS

SHEET TITLE:
SIGNAGE, OUTBUILDING
PLANS AND ELEVATIONS

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DATE:
SCALE:
DRAWN BY: JR
CHECKED BY: JB
JOB NO.: 84.08A

SHEET NO.:
A-2.1.10

Attachment C




Land Use & Zoning Map

Margaritaville Hollywood Beach Resort






PLANNING AND
DEVELOPMENT SERVICES

Legend

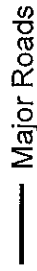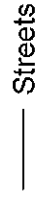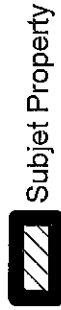

Zoning

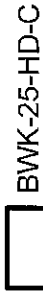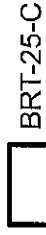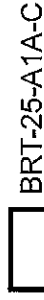

Land Use

